Mallott Arslan Addition/Renovation

OWNER

Steve Mallott Yunus Arslan 109 11th Street, SE Washington, DC 20003

ARCHITECT

Inscape Studio 1113 V Street, NW Washington, DC 20009 202.288.4081

STRUCTURAL

Bel Engineering, LLC 4542 Beech Road Temple Hills, MD 20748


MEP

BTM Engineers 4712 Babbling Brook Dr Olney, MD 20832 240.701.7871


CONTRACTOR

LEC Construction 6809 Wisconsin Avenue Chevy Chase, MD 20815

Permit Set October 25 2021

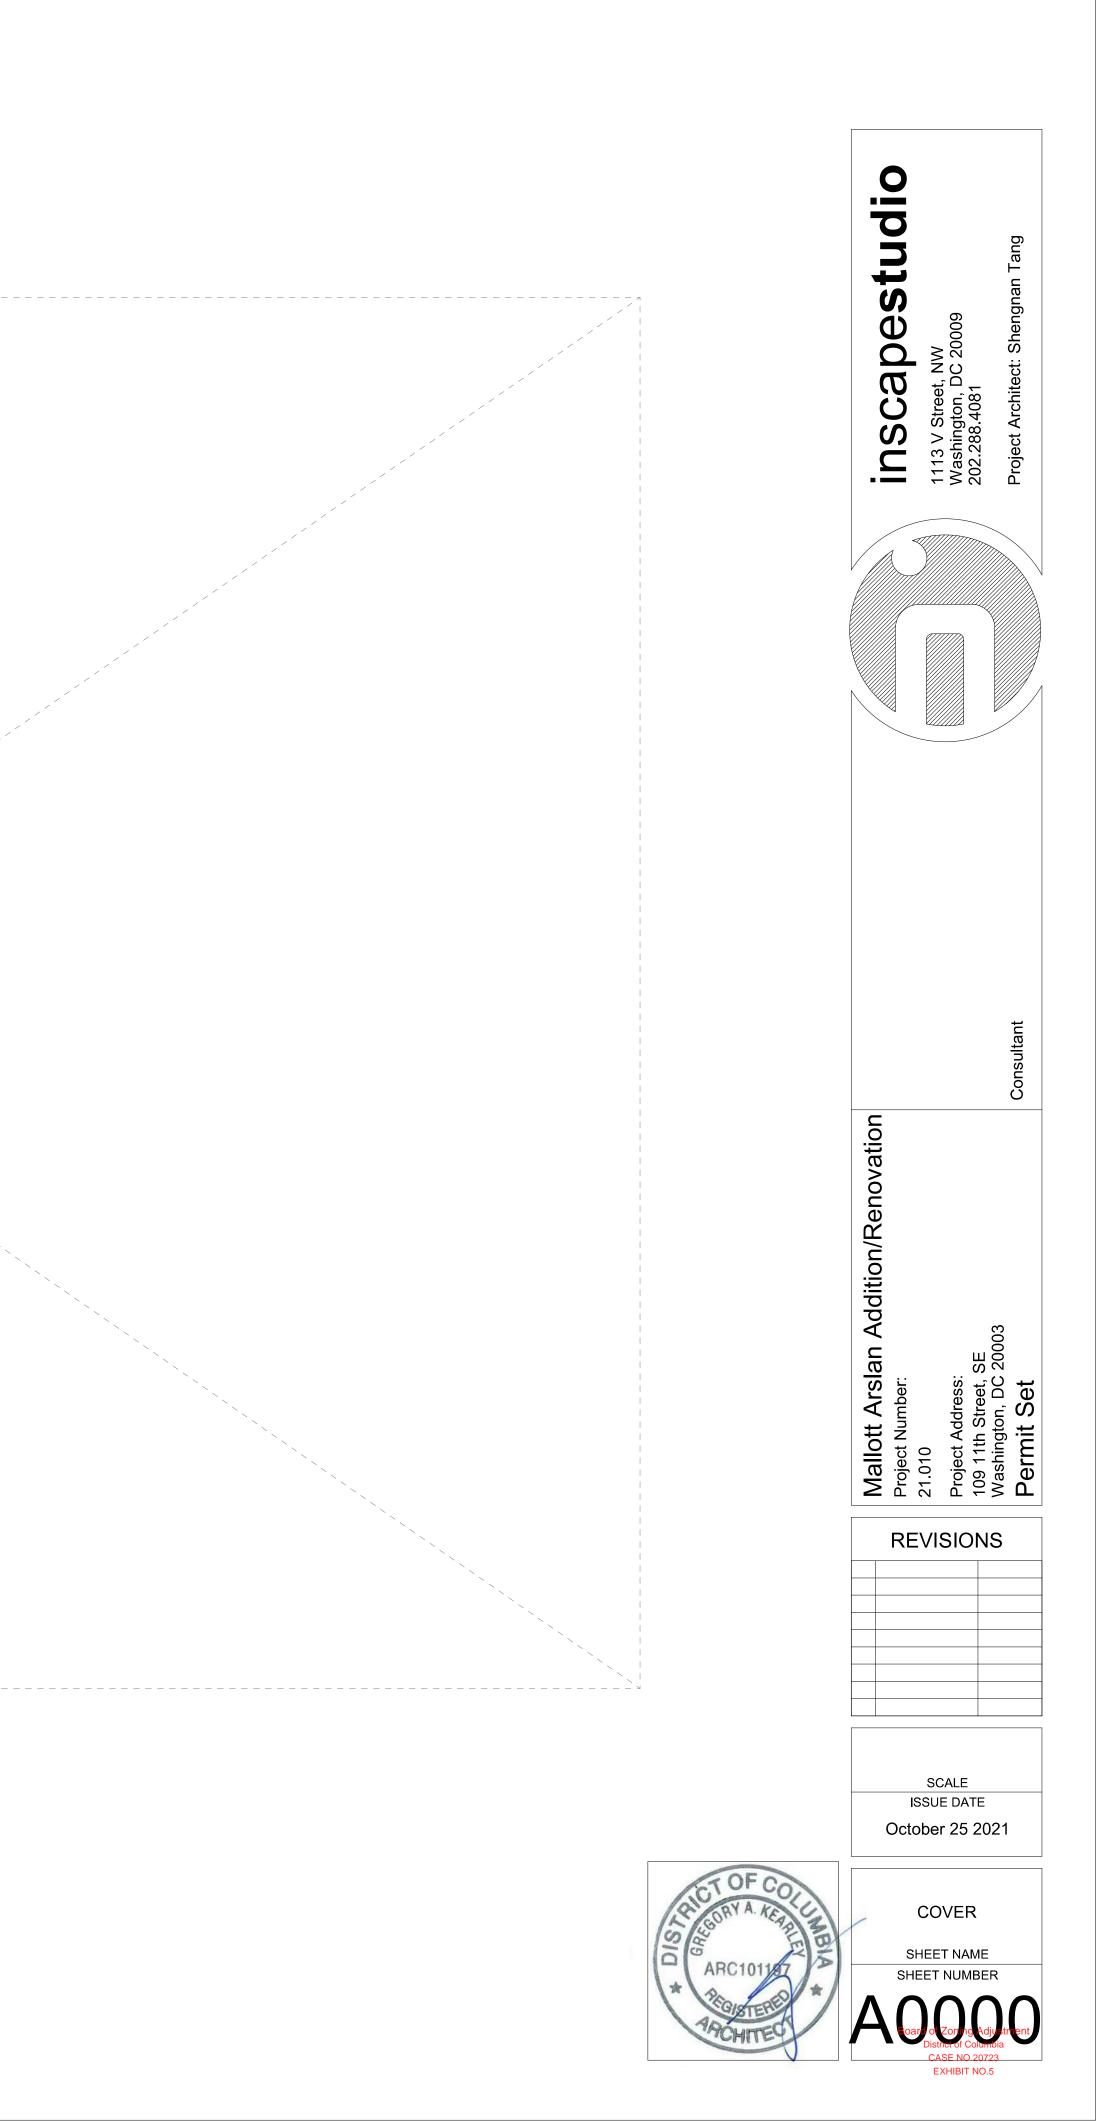

DRAWING KEY

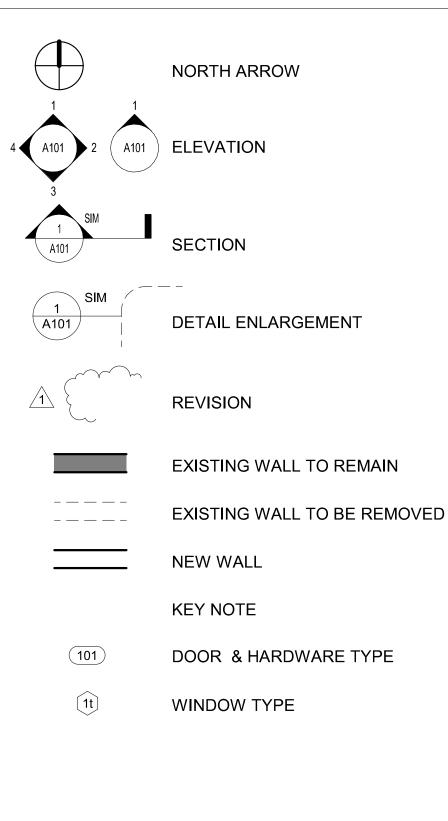

ABBREVIATIONS				
A/C	AIR CONDITIONING			
AFF	ABOVE FINISHED FLOOR			
BD	BOARD			
BLDG	BUILDING			

CAB

CLG CONST CABINET

CEILING

CONSTRUCTION

D DEMOLISH DISP DS DISPOSAL DIMMER SWITCH DW DISHWASHER DWG DRAWING E, EXST EXISTING FIN.FL FIXT FINISHED FLOOR FIXTURE FL FLOOR FT FEET IN ' G GRAMS GAL GALLONS GFI GROUND FAULT INTERRUPT GWB GYPSUM WALL BOARD GYP.BD GYPSUM WALL BOARD ST HEIGHT ΗT IN INCHES INSUL INSULATION LITERS LB POUNDS MDF MEDIUM DENSITY FIBERBOARD MO MASONRY OPENING MW, MICROMICROWAVE NIC NOT IN CONTRACT OFCI OWNER FURNISHED, CONTRACTOR INSTALLED OPT OPTION PLAM PLASTIC LAMINATE PNT, PTD PAINT, OR PAINTED R RELOCATE BU RA RANGE REFERENCE RE REF REFRIGERATOR, REFERENCE REQ REQUIRED RO ROUGH OPENING SA SUPPLY AIR STRUCTURAL CONCRETE INSULATE PANEL SCIP STRUCTURAL INSULATED PANEL SIP SIM SIMILAR SS, S.STL STAINLESS STEEL TBD TOS TO BE DETERMINED TOP OF SLAB BL TYP TYPICAL UON UNLESS OTHERWISE NOTED 201 U/S UNDERSIDE 201 VIF VERIFY IN FIELD ME VOC VOLATILE ORGANIC COMPOUNDS 201 201 W/ WITH

WOOD WD WWF WOVEN WIRE FABRIC

PROJECT INFO

OWNER:	STEVE MALLOTT YUNUS ARSLAN 109 11TH STREET, SE WASHINGTON, DC 20					
ARCHITECT:	INSCAPE STUDIO 1113 V STREET, NW WASHINGTON, DC 20	009				
ADDRESS:	109 11TH STREET, SE WASHINGTON, DC 20					
	LOT: 0822 SQUARE: 0968					
WARD: 6 CODE: 2017 DC CONSTRUCTION CODES						
ZONE DISTRICT:						
	HILL HISTORIC DISTRI	ICT				
ZONING DATA	ALLOWED/REQ	. PROPOSED				
HEIGHT <i>(303)</i>	35'-0" MAX	20' -0"				
STORIES	3 STORIES	2 STORIES				
LOT SIZE <i>(201)</i> MIN. LOT ARE MIN. LOT WID)	1,825 SF 14' - 8" TO 23' - 6"				
LOT OCCUPANC	Y <i>(304)</i> 60% MAX	74% EXISTING				
	=1,095 SF	AND PROPOSED =1,347.51 SF				
SETBACKS (207, FRONT	WITHIN THE RA THE RANGE OF SETBACKS OF ON THE SAME S	BLOCK WHERE				
SIDES REAR	NONE 20' - 0"	NONE 28' -0"				
BUILDING DATA						
EXISTING GROS	S FLOOR AREA:					
SECOND FLOOR: 315.06 SF FIRST FLOOR: 1,347.51 SF TOTAL: 1,662.57 SF						
SEC	5T FLOOR: 1,34	52.97 SF 17.51 SF 00.48 SF				
BLDG CODE						
	DC BUILDING CODE AI ONAL BUILDING CODE					
	DC MECHANICAL COD ONAL MECHANICAL CC					
	DC PLUMBING CODE ONAL PLUMBING CODE	E (IPC)				
2015 INTERNATIONAL PLUMBING CODE (IPC) <u>ELECTRICAL:</u> 2017 DCMR 12C, DC ELECTRICAL CODE 2014 NATIONAL ELECTRICAL CODE (NEC) NEDA 70						
2014 NATIONAL ELECTRICAL CODE (NEC), NFPA 70 <u>FIRE:</u> 2017 DCMR 12H, DC FIRE CODE 2015 INTERNATIONAL EIRE CODE (IEC)						
2015 INTERNATIONAL FIRE CODE (IFC) <u>ENERGY:</u> 2017 DCMR 12I, DC ENERGY CONSERVATION CODE 2015 INTERNATIONAL ENERGY CONSERVATION CODE – RESIDENTIAL PROVISIONS 2013 ANSI/ASHRAE/IES 90.1						
<u>FUEL AND GAS:</u> 2017 DCMR 12D, DC FUEL GAS CODE 2015 INTERNATIONAL FUEL GAS CODE (IFGC)						
GREEN CONSTRUCTION: 2017 DCMR 12K, DC GREEN CONSTRUCTION CODE 2012 INTERNATIONAL GREEN CONSTRUCTION CODE (IGCC)						

PROJECT DESCRIPTION

RENOVATION AND ADDITION TO AN EXISTING TWO-STORY ROW-HOUSE. RENOVATION TO INCLUDE THE KITCHEN AND FIRST FLOOR MASTER BEDROOM. SECOND FLOOR MASTER BEDROOM ADDITION.

DRAWING INDEX

STRUCTURAL

S0001 GENERAL NOTES S0101 FIRST FLR., SECOND FLR. & ROOF FRAMING PLANS S0200 WALL BRACING PLANS, NOTES AND DETAILS S0301 SECTIONS AND TYPICAL DETAILS

PLUMBING

P0000 P0100 P0200

NOTES & SPECS PLUMBING PLAN RISER DIAGRAMS P0300 DETAILS & SCHEDULES

MECHANICAL


M0000 M0100 HVAC PLAN M0200 DETAILS & SCHEDULES

NOTES & SPECS

ELECTRICAL

E0000 ELECTRICAL COVER SHEET E0100 ELECTRICAL NEW LIGHTING PLAN E0200 ELECTRICAL NEW POWER PLAN

VICINITY

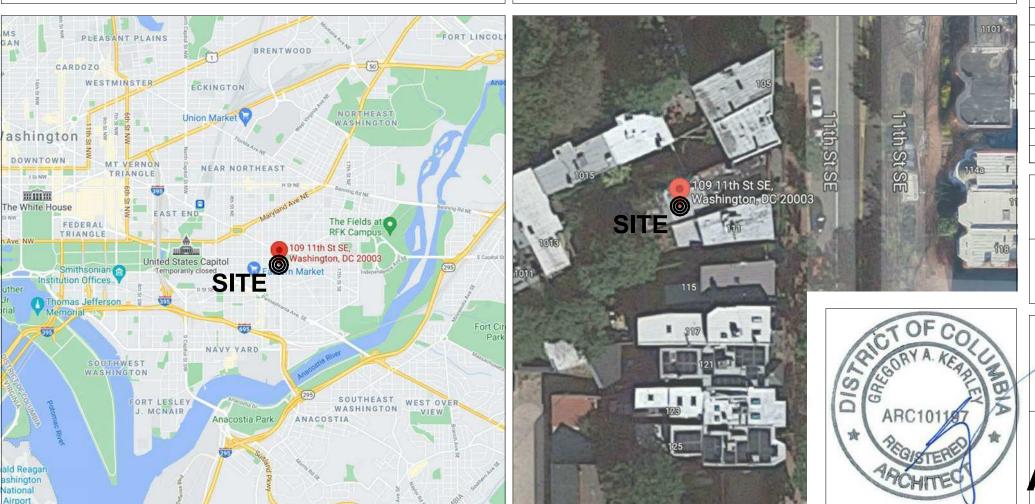

DRAWING INDEX

GENERAL

A0000 COVER A0001 DRAWING INDEX & PROJECT INFORMATION A0002 EXISTING CONDITION PHOTOS A0003 STREET VIEW

CIVIL

C0101 EROSION AND SEDIMENT CONTROL SITE PLAN C0102 EROSION AND SEDIMENT CONTROL DETAILS AND NOTES

LANDSCAPE

DEMOLITION

D0100 EXISTING/DEMOLITION SITE PLAN D0101 DEMOLITION PLANS D0102 DEMOLITION ELEVATIONS

ARCHITECTURAL

A0100	PROPOSED SITE PLAN
A0101	PROPOSED FLOOR PLANS
A0111	FINISH PLANS
A0121	POWER PLANS
A0131	REFLECTED CEILING PLANS
A0201	PROPOSED ELEVATIONS
A0301	BUILDING SECTION
A0401	INTERIOR ELEVATIONS - KITCHEN
A0402	INTERIOR ELEVATIONS - BATHROOMS
A0501	WALL TYPES
A0502	ROOF AND FLOOR ASSEMBLIES
A0601	DOOR & WINDOW SCHEDULES

LOCATION


inscapestudio	1113 V Street, NW Washington, DC 20009 202.288.4081	Project Architect: Shengnan Tang
ovation		Consultant
Mallott Arslan Addition/Renovation	21.010 Project Address: 109 11th Street, SE	Washington, DC 20003 Permit Set
RE	VISION	S
	2" = 1'-0"	
IS	SCALE SSUE DATE ber 25 20	21
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FRONT VIEW - 1




FRONT VIEW - 2




REAR VIEW

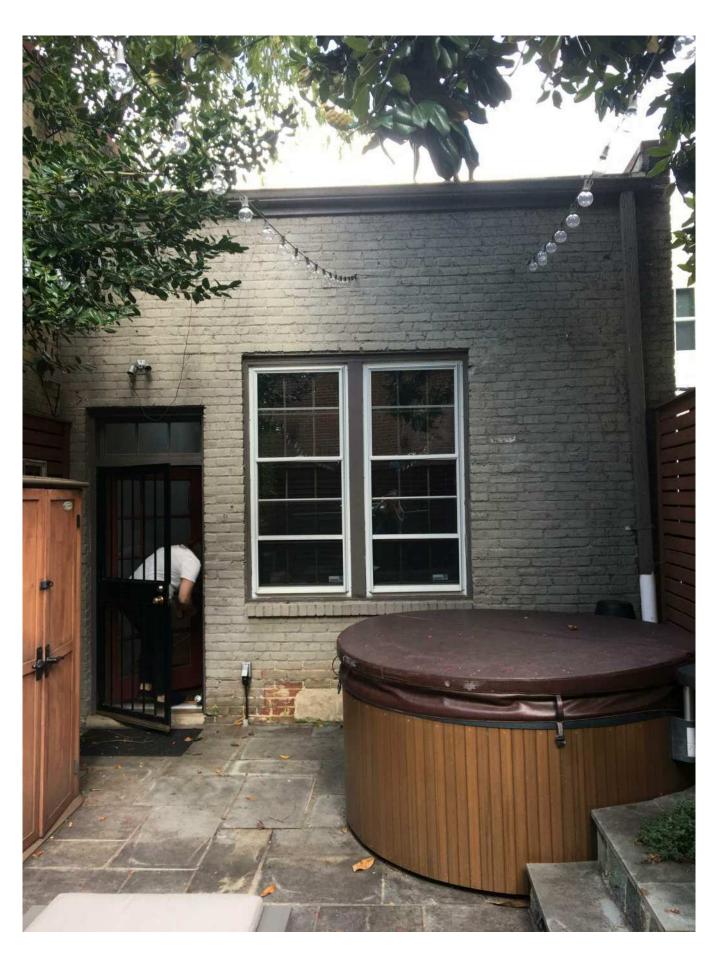
KEY NOTES


GENERAL NOTES

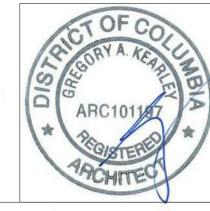


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RE	VISION	S		
	SCALE SUE DATE ber 25 20	21		
EXISTING CONDITION PHOTOS SHEET NAME SHEET NUMBER ANNON2				

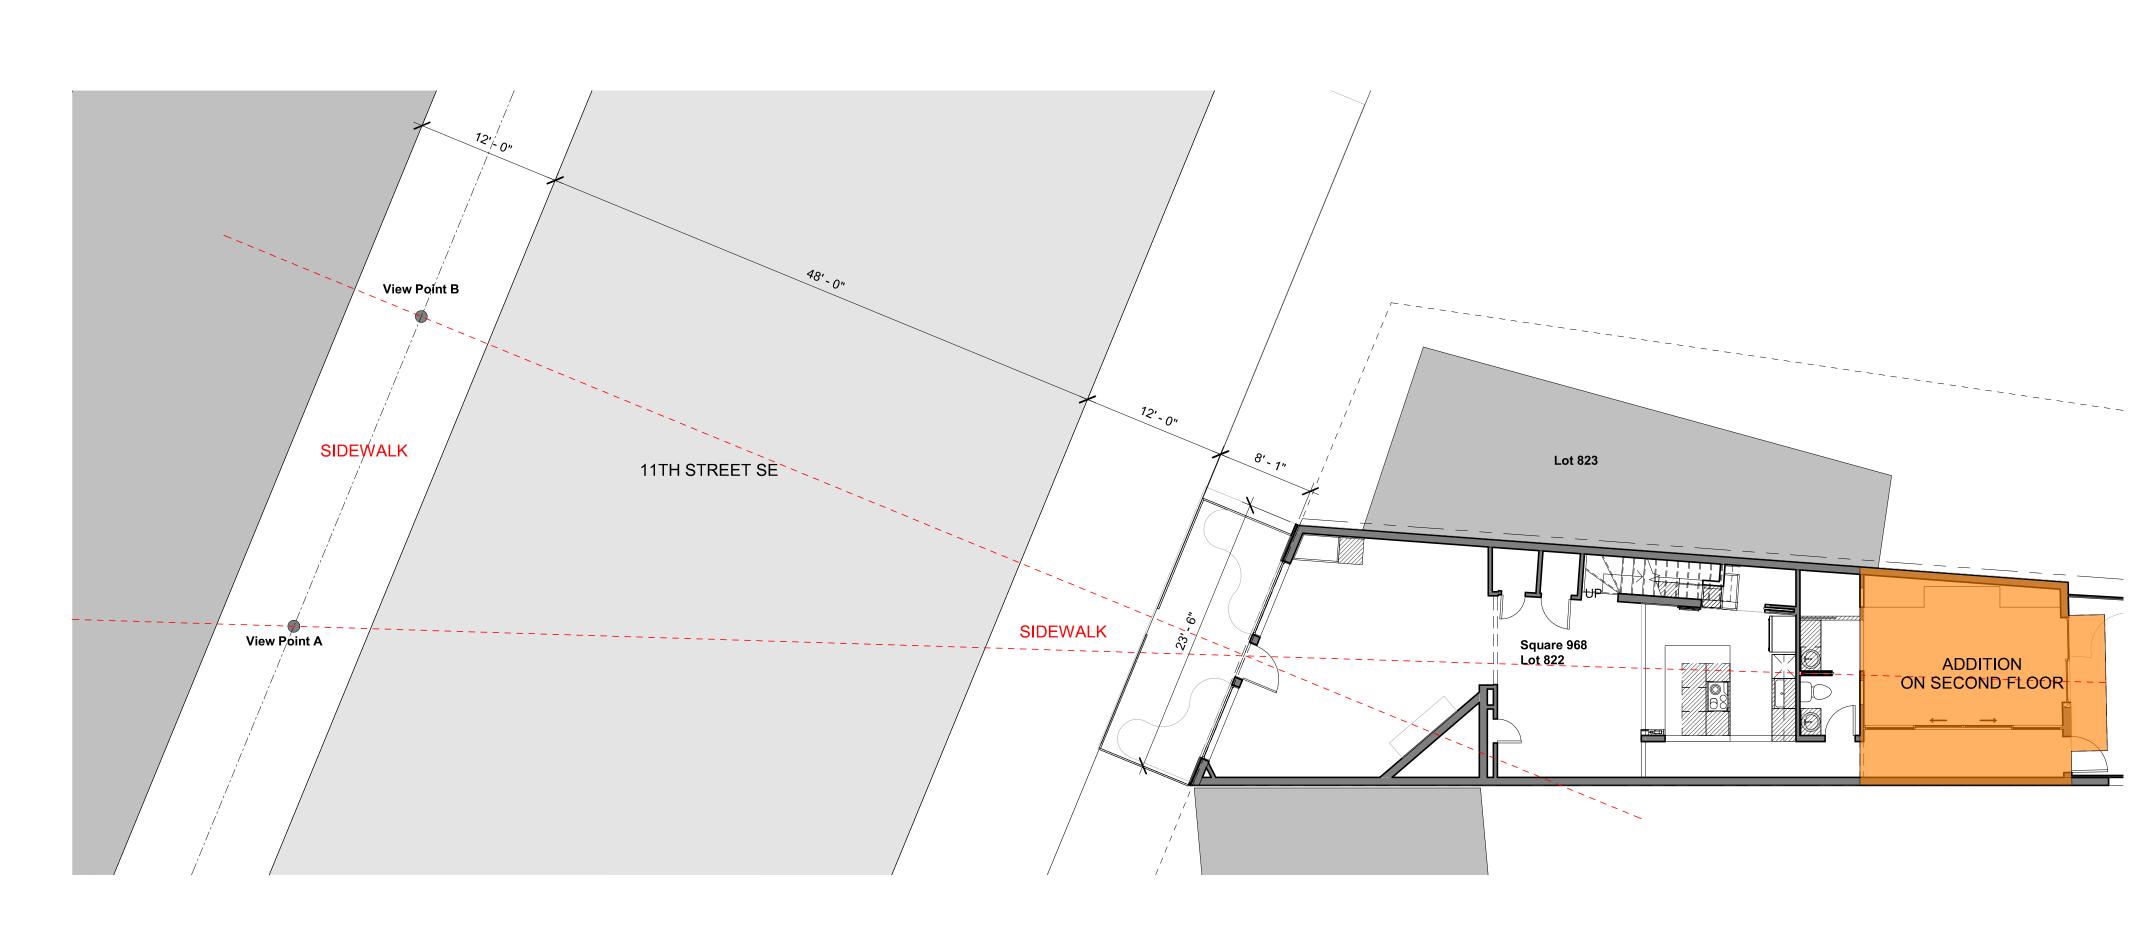


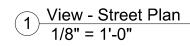

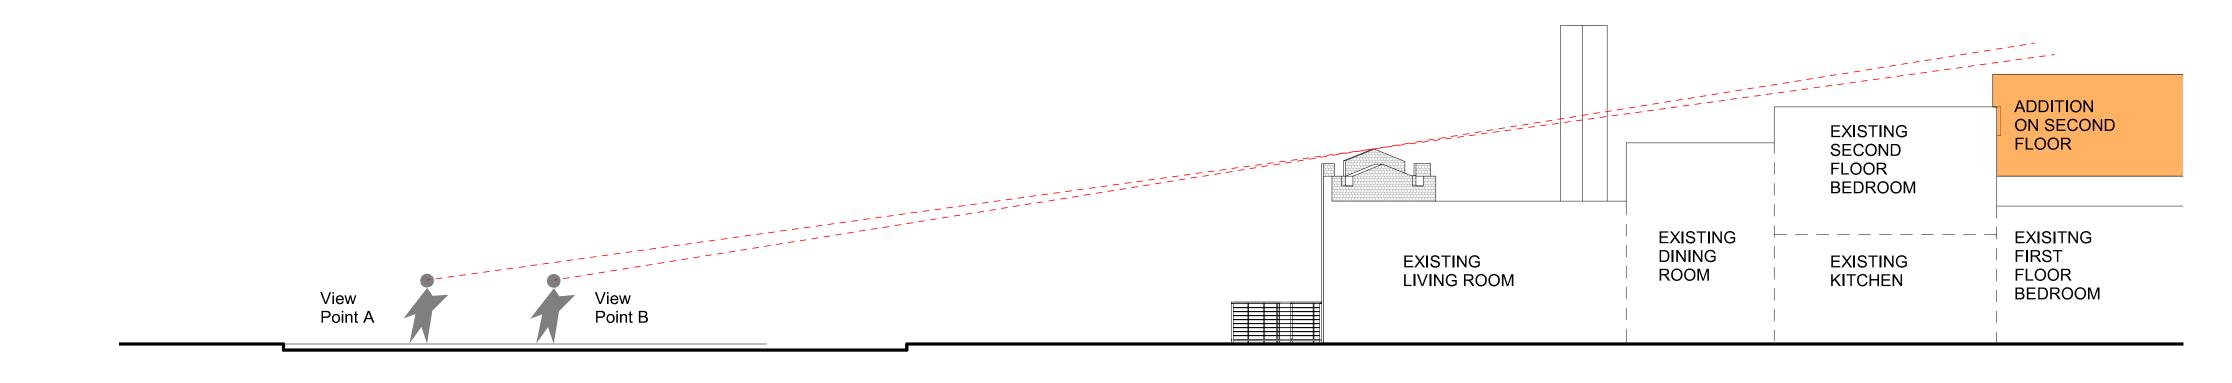



2 View - Street Section 1/8" = 1'-0"

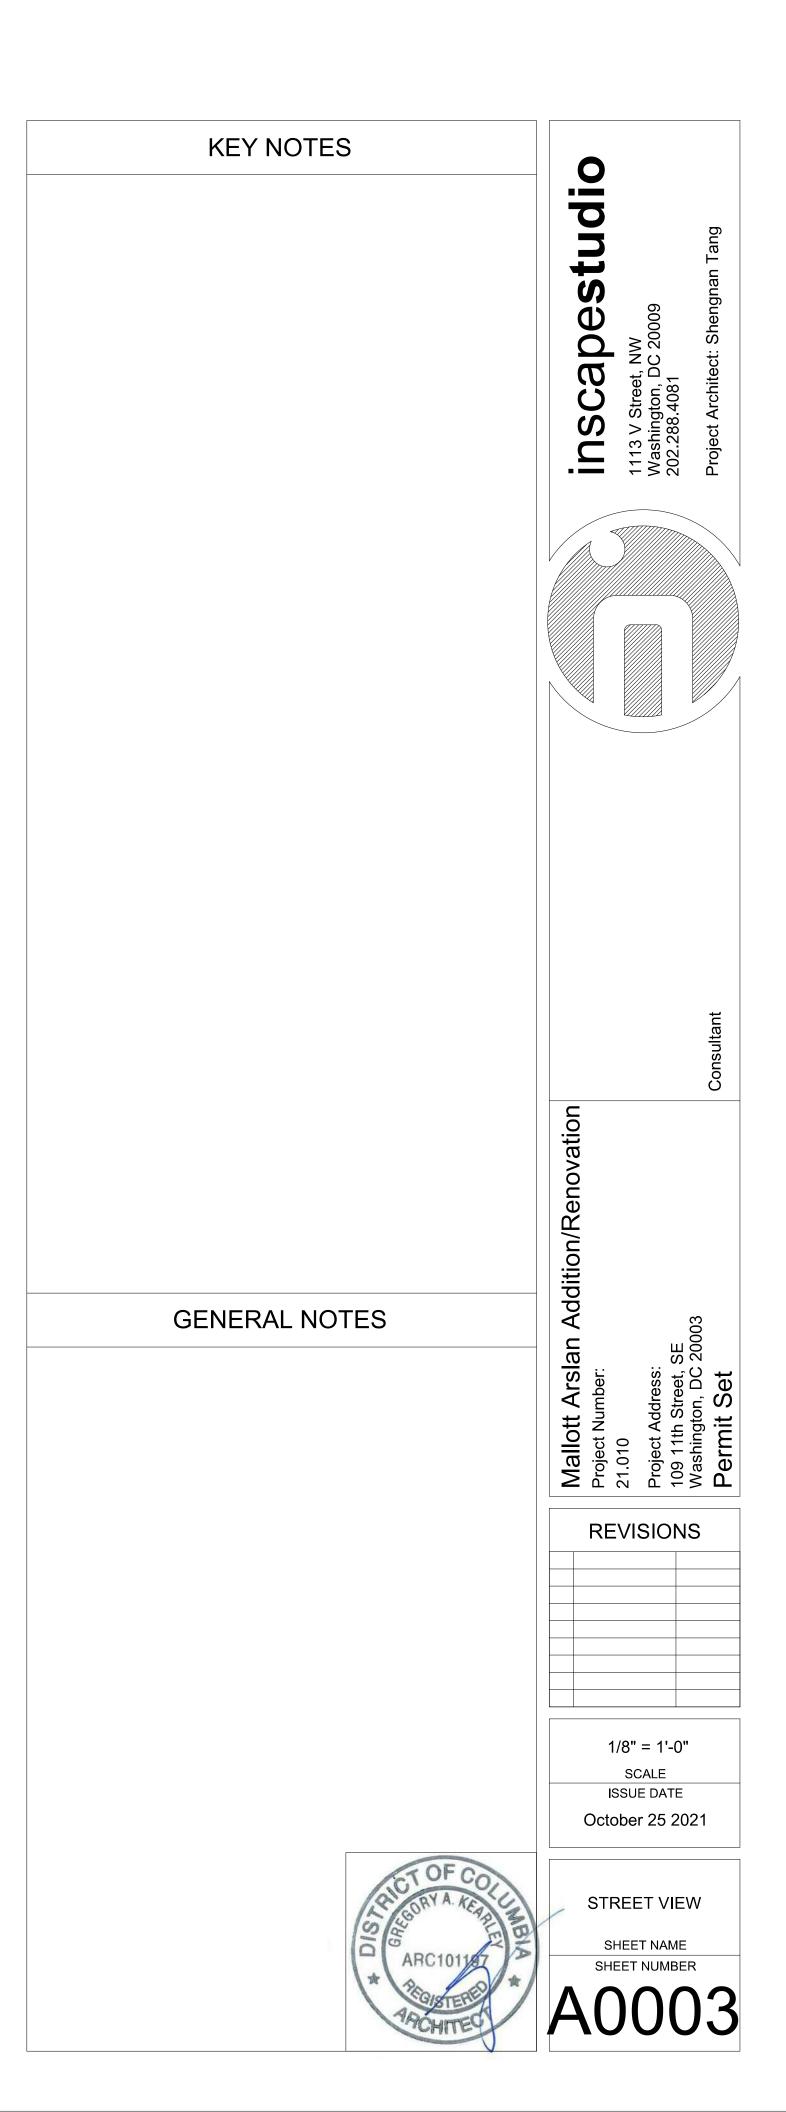

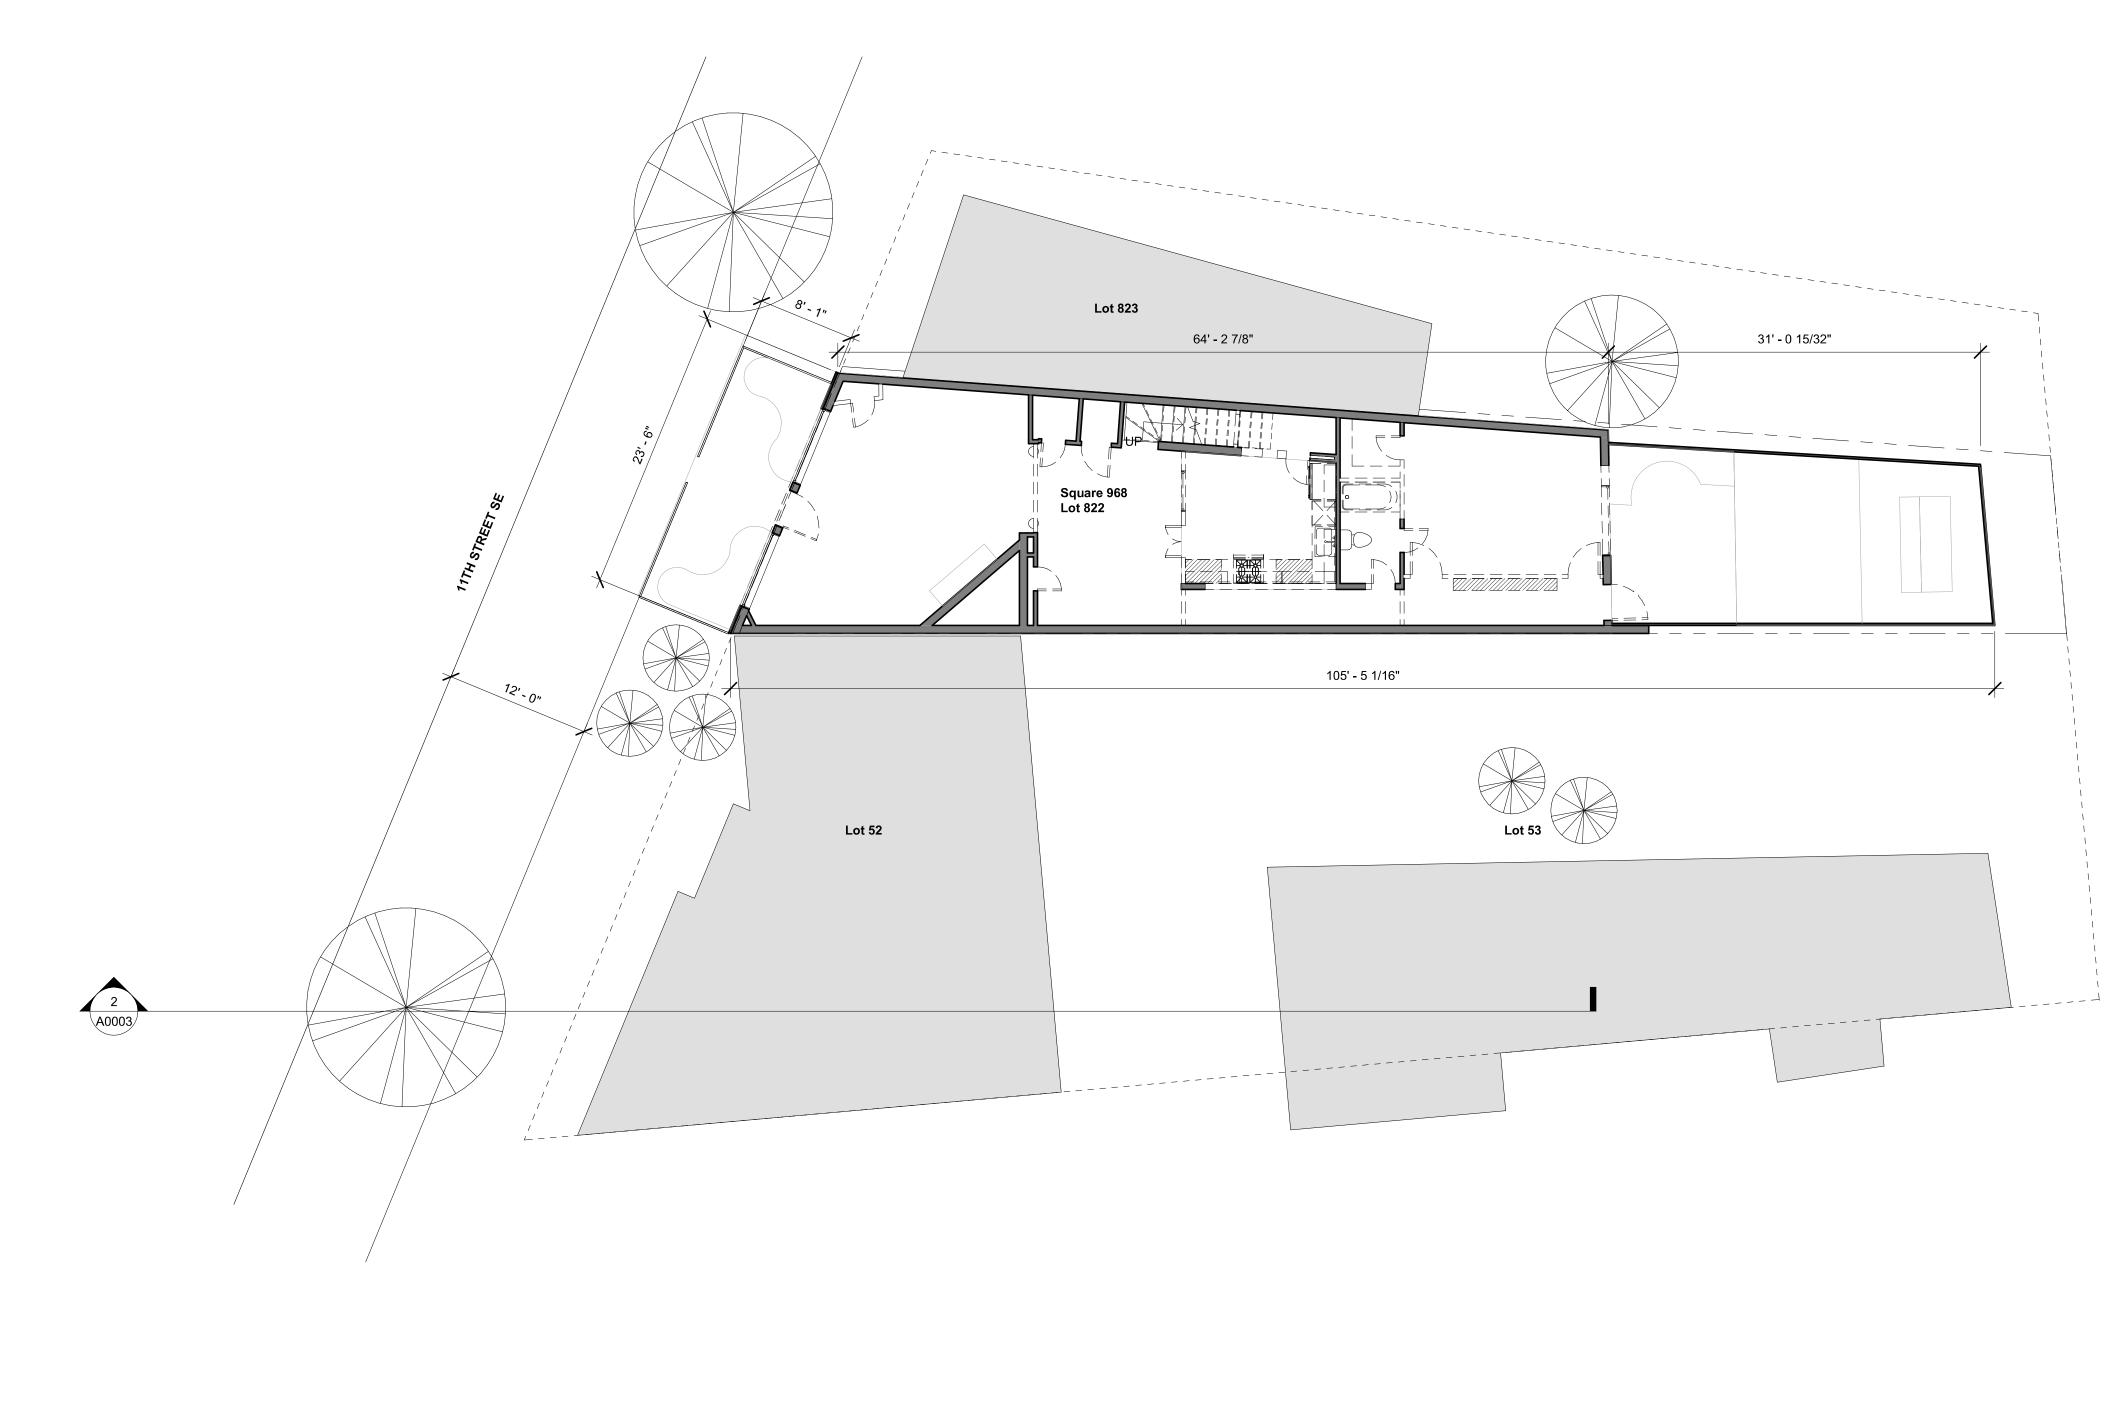

1 EXISTING/DEMOLITION SITE PLAN 1/8" = 1'-0"

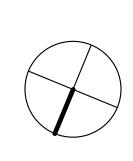

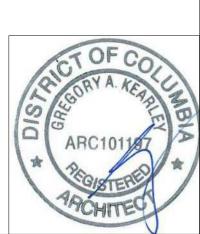



Mallott Arslan Addition/Renovation Project Number: 21.010 SE : 20003 street, South DC Project ... 109 11th S Washingto **Permit** REVISIONS 1/8" = 1'-0" SCALE ISSUE DATE October 25 2021 EXISTING/DEMOLITION SITE PLAN SHEET NAME SHEET NUMBER D0100


inscapestudio


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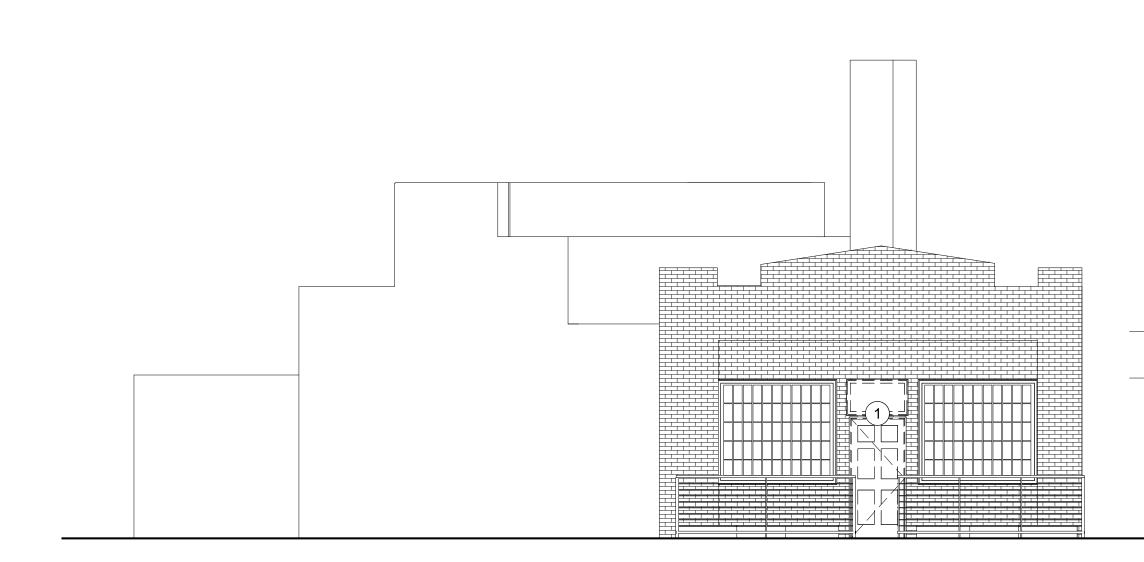
v Street, NW ington, DC 200 38.4081

1113 V Washin 202.288







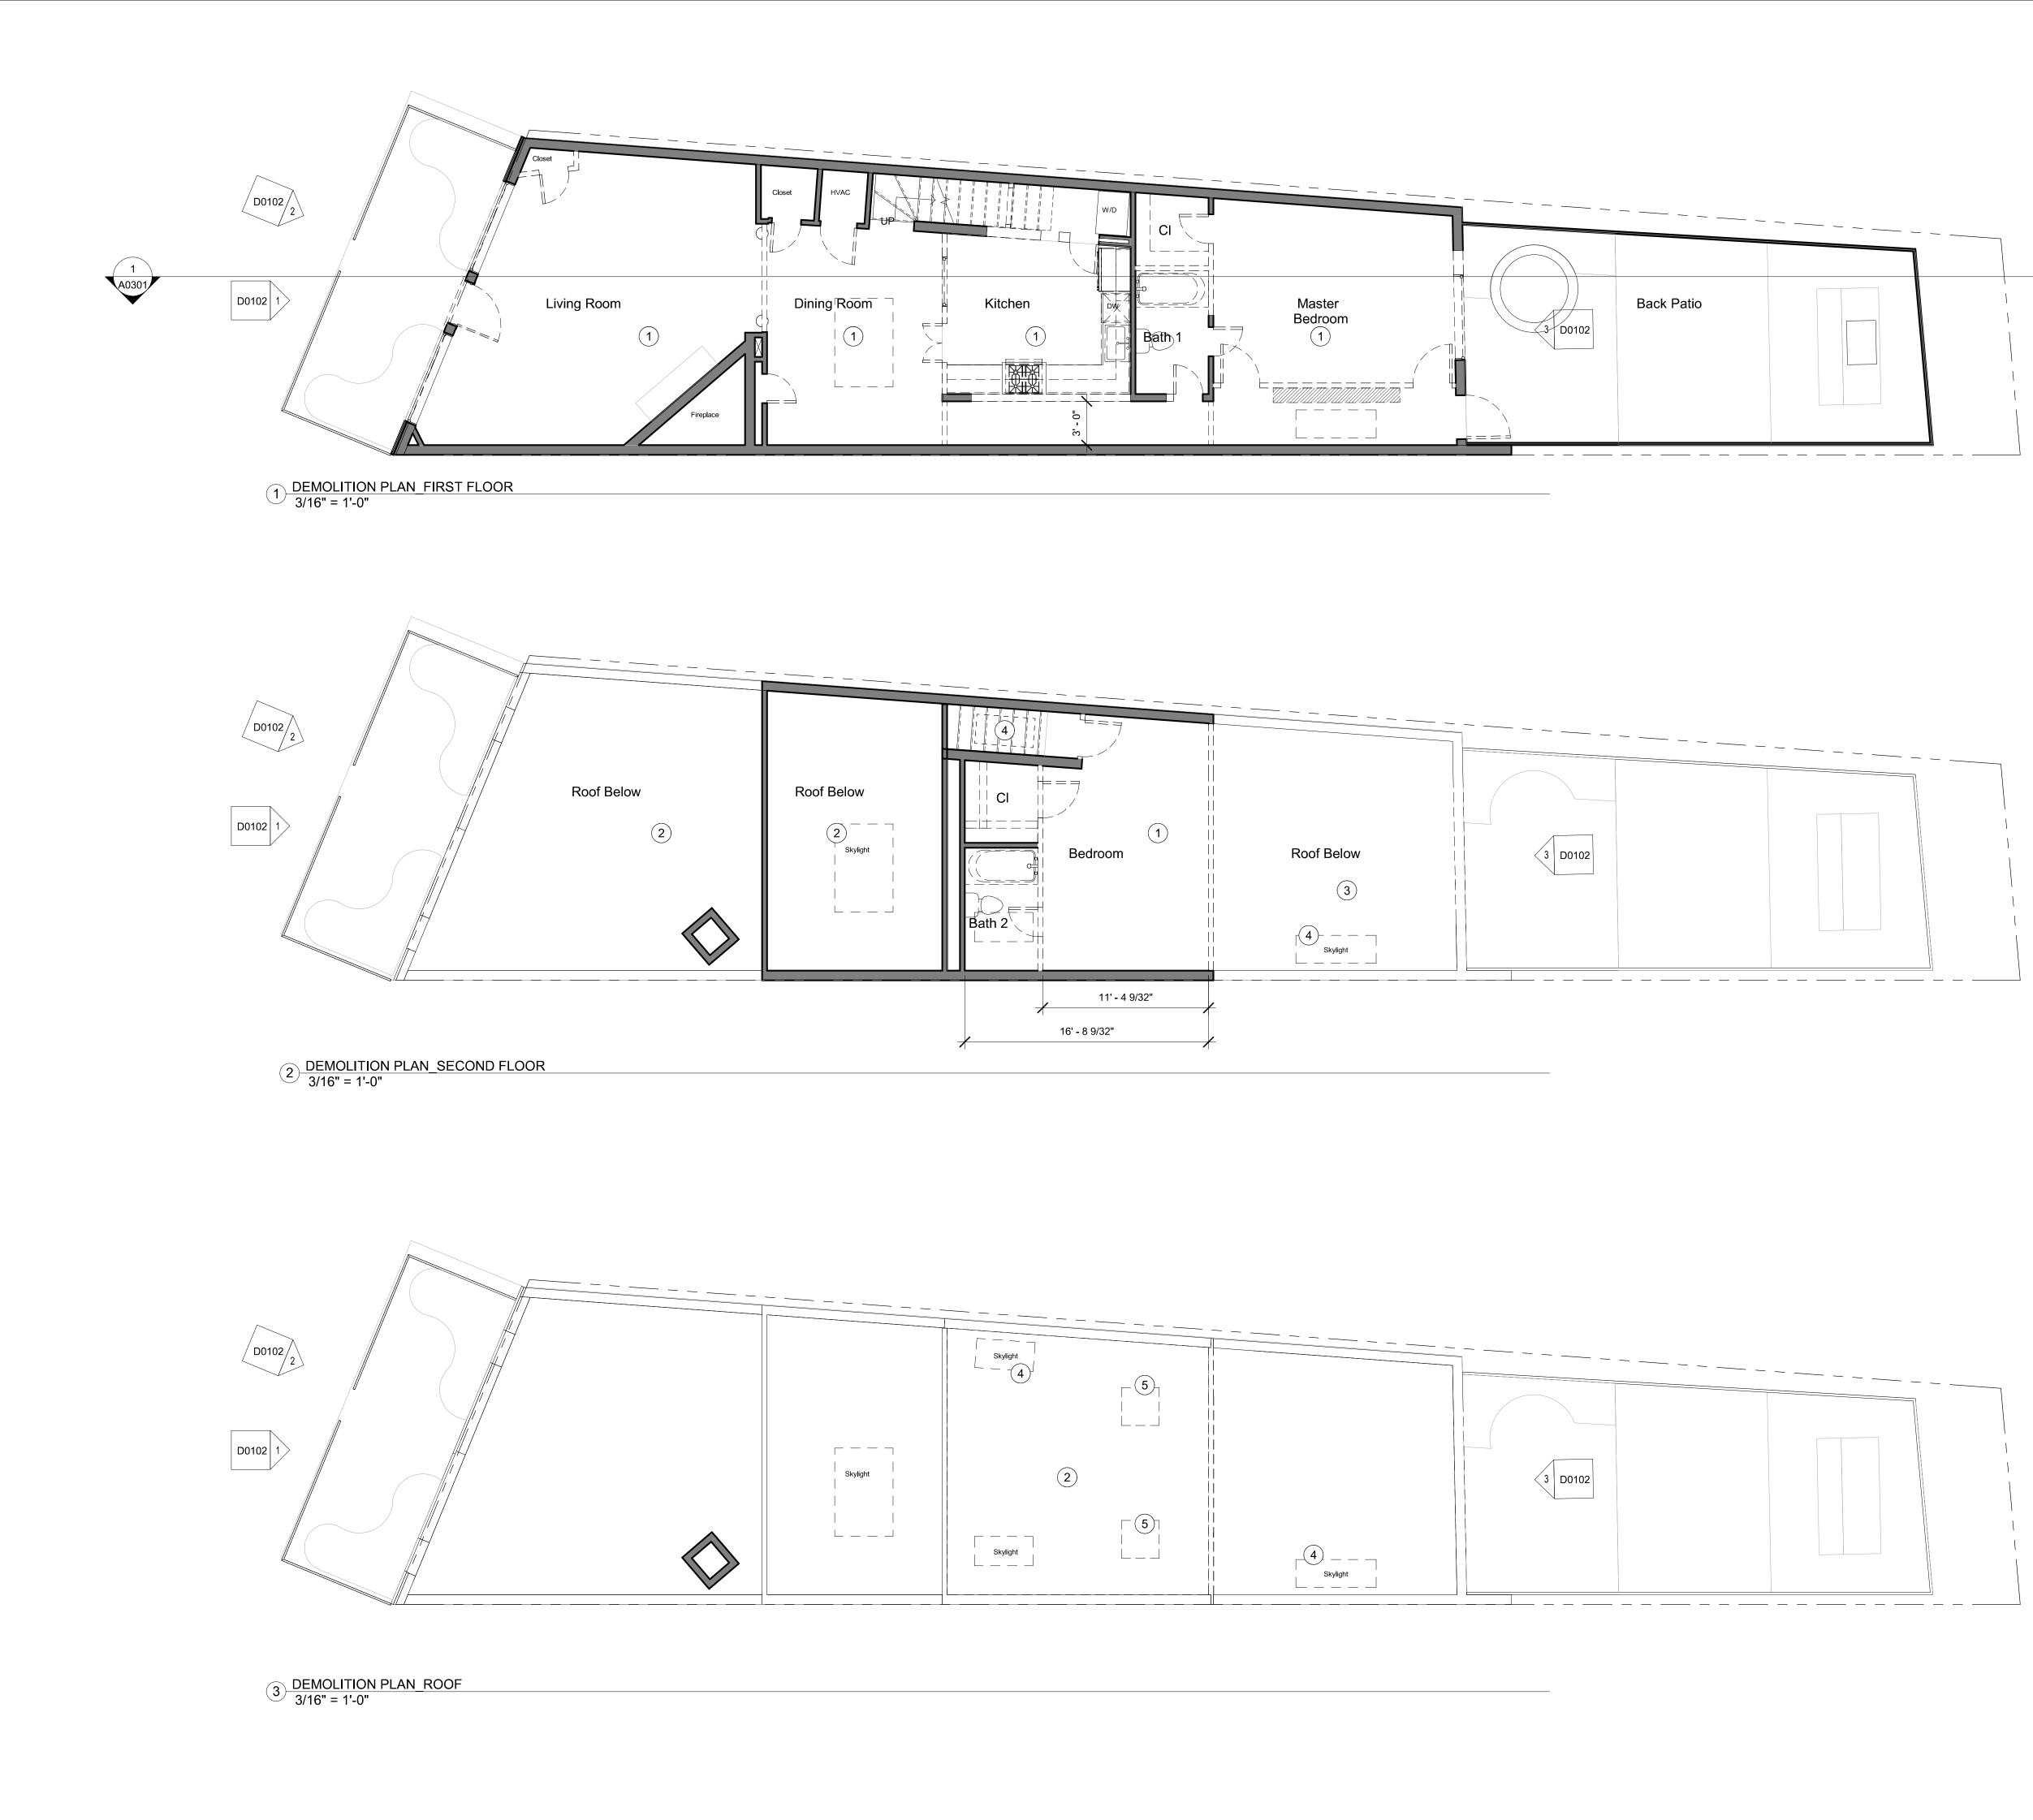

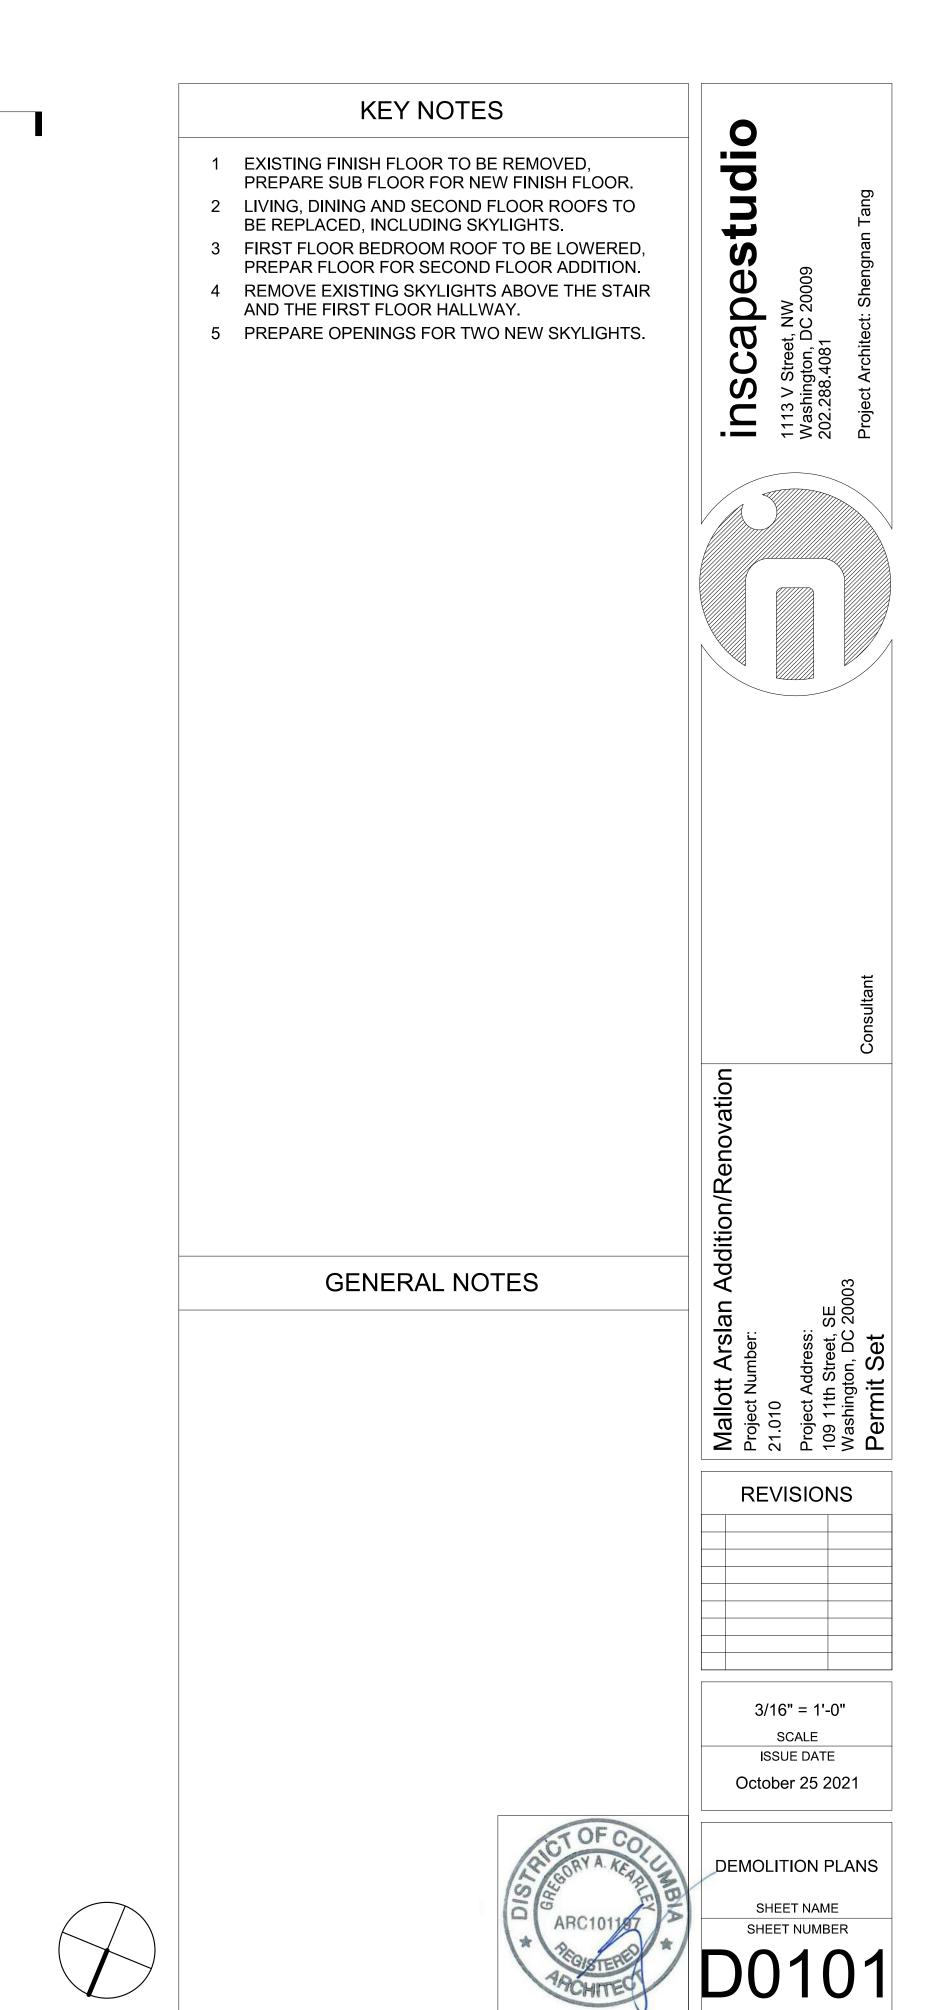


2 DEMOLITION ELEVATION - FRONT - 2 3/16" = 1'-0"

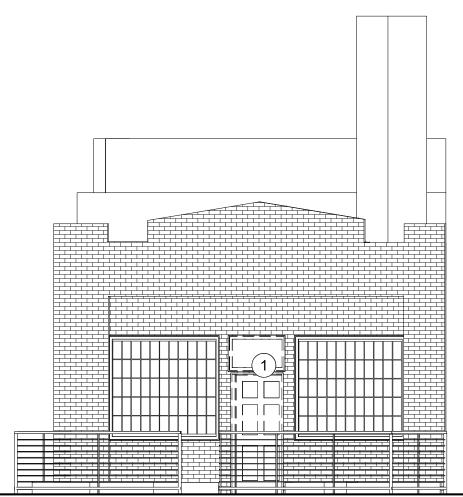

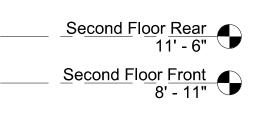


First Floor 0' - 0"

 $1 \frac{\text{DEMOLITION ELEVATION - FRONT - 1}}{3/16" = 1'-0"}$

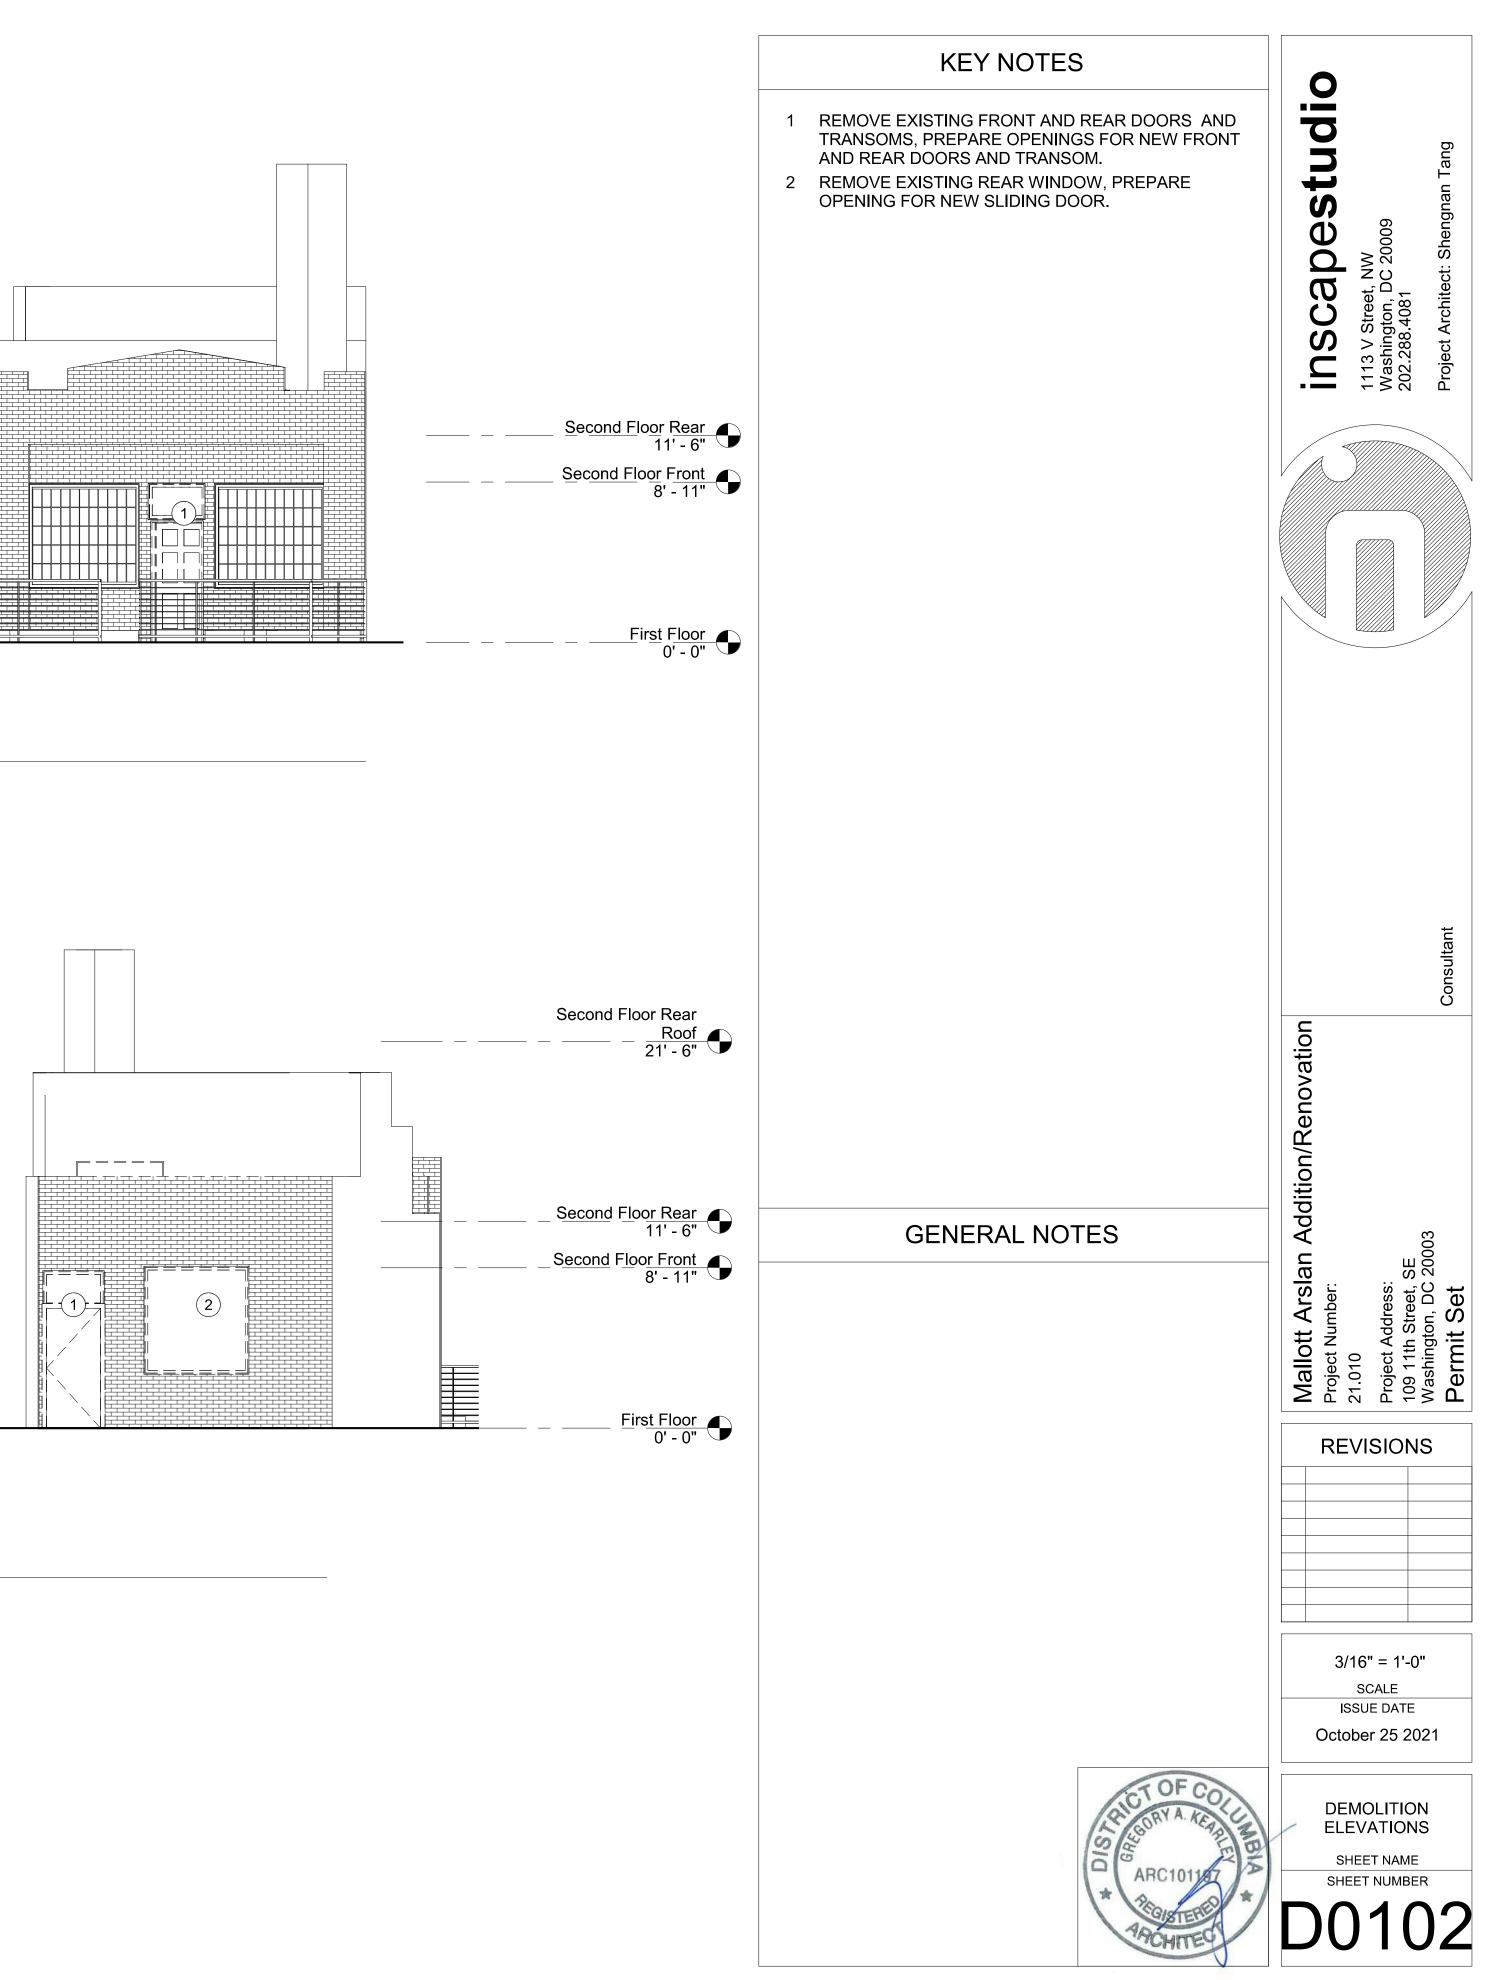


 $3 \frac{\text{DEMOLITION ELEVATION - REAR}}{3/16" = 1'-0"}$

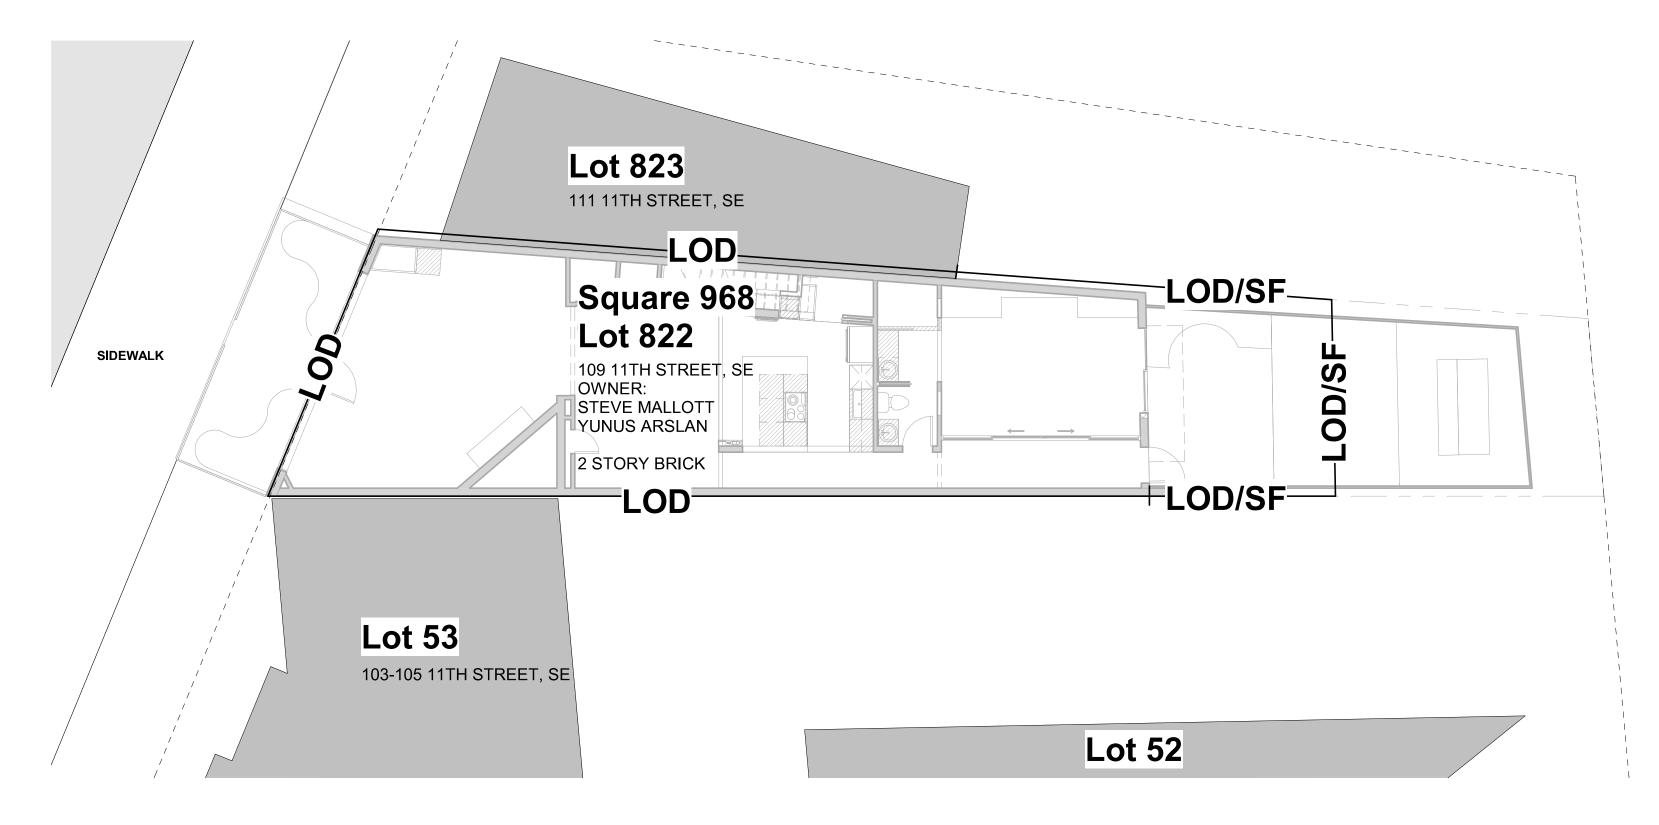

EROSON AND SEDIMENT CONTROL 1 SITE PLAN 1/8" = 1'-0"

VICINITY

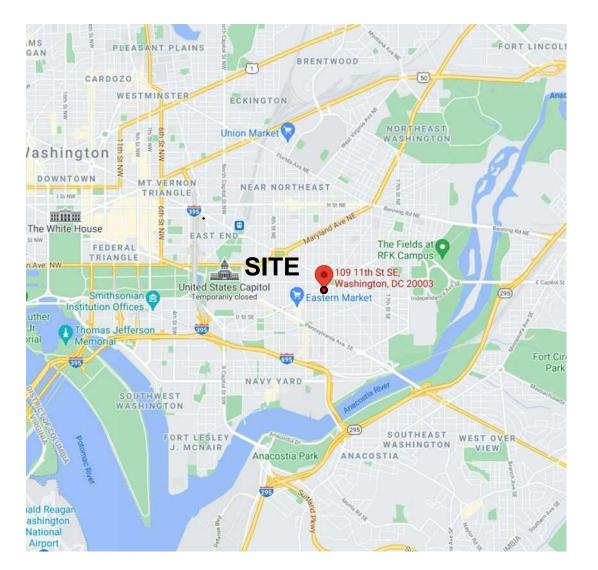

OWNER

Steve Mallott Yunus Arslan 109 11th Street, SE Washington, DC 20003

STANDARD EROSION AND SEDIMENT CONTROL MEASURES AND SEQUENCE

- INSTALL SILT FENCE AS SHOWN.
- 3

NARRATIVE

- TWO STORY HOUSE.

ONCE SILT FENCE HAS BEEN INSTALLED AND INSPECTED BY THE SEDIMENT AND EROSION CONTROL INSPECTOR PROCEED WITH THE CONSTRUCTION OF THIS STORY ADDITION, CARRIAGE HOUSE, STAIRS, FRONT PORCH AND PARKING AREA.

FOR CONSTRUCTION OF WATER AND SEWER CONNECTION TO THE PROPOSED BUILDING, PRACTIVE SAME DAY STABILIZATION ON NOAA PREDICTED 3-DAY DRY WEATHER CONDITION.

ONCE CONSTRUCTION IS COMPLETED, AND WITH THE APPROVAL OF SEDIMENT CONTROL INSPECTOR, REMOVE THE SEDIMENT AND EROSION CONTROL MEASURES.

THE 1,825 S.F. SITE IS ABOUT 110 FEET SOUTH OF THE INTERSECTION OF 11ST ST SE AND NORTH CAROLINA AVE SE IN SOUTHEAST WASHINGTON DC. THE LEGAL DESCRIPTION OF THE SITE IS LOT 822. EXISTING CONDITION OF THE SITE CONSISTS OF


PROPOSED IMPROVEMENTS OF SECOND FLOOR ADDITION OF 17' EXTENSION ABOVE EXISTING HOUSE FIRST FLOOR. THERE IS NO DISTURBANCE DUE TO THE PROPOSED ACTIVITY.


THERE WILL BE NO CHANGE IN ELEVATION.

GENERAL MEASURES


- SEDIMENT AND EROSION CONTROL MEASURES SHALL BE INSTALLED BEFORE THE START OF ANY EXCAVATION AND/OR CONSTRUCTION AS PER STANDARS AND SPECIFICATIONS FOR SOIL EROSION AND SEDIMENT CONTROL FOR THE DISTRICT OF COLUMBIA. IF AN ON-SITE INSPECTION REVEALS FURTHER EROSION CONTROL MEASURES ARE NECESARRY, THE SAME SHALL BE PROVIDED.
- 2. ALL DEBRIS IS TO BE REMOVED FROM SITE.
- ALLEY AND/OR STREETS/SIDEWALKS SHALL BE 3. SWEPT CLEAN AT ALL TIMES DURING DEMOLITION, EXACATION AND CONSTRUCTION.
- 4. ALL CATCH BASINS AND DRAIN AREAS SHALL BE PROTECTED DURING EXACATION AND CONSTRUCTION.
- IF ANY BASINS OR DRAINS BECOME CLOGGED 5. AS A RESULT OF DEMOLITION, EXACATION OR CONSTRUCTION THE CONTRACTOR SHALL BE **RESPONSIBLE FOR ITS CLEANING.**
- WHEN SEDIMENT TRAP TANK HAS REACHED 6. 67% CAPACITY, CLEANING OUT OF SAME IS REQUIRED.
- ANY STOCKPILING, REGARDLESS OF LOCATION 7. SHALL BE STABILIZED AND COVERED WITH PLASTIC OR CANVAS, AFTER ITS ESTABLISHEMENT AND FOR DURATION OF THE PROJECT.
- AFTER RAZING OR DEMOLITION, THERE IS THE 8. NEED FOR GROUNDCOVER TO PREVENT EROSION AND SEDIMENT RUNOFF FROM OCURRING. SUCH AS APPLYING SEED, SOD, PAVE, BRICKBAT OR MULCH, ETC.
- TEMPORARY SEDIMENT CONTROL DEVICES MAY BE REMOVED, WITH PERMISSION OF DCRA INSPECTOR, WITHIN THIRTY (30) CALENDAR DAYS FOLLOWING ESTABLISHMENT OF PERMANENT STABILIZATION IN ALL.
- 10. WHERE DEEMED APPROPIATE BY THE ENGINEER OR INSPECTOR, SEDIMENT BASINS AND TRAPS MAY NEED TO BE SURROUNDED WITH AN APPROVED SAFETY FENCE. THE FENCE MUST ONFORM TO LOCAL ORDINANCES AND REGULATIONS. THE DEVELOPER OR OWNER SHALL CHECK WITH LOCAL GUILDING OFFICIALS ON APPLICABLE SAFETY **REQUIREMENTS. WHERE SAFETY FENCE IS** DEEMED APPROPIATE AND LOCAL ORDINANCES DO NOT SPECIFY FENCING SIZES AND TYPES, THE FOLLOWING SHALL BE USED AS A MINIMUM STANDARD: THE SAFETY FENCE MUST BE MADE OF WELDED WIRE AND AT LEAST 42 INCHES HIGH, HAVE POST SPACED NO FARTHER

LEGEND

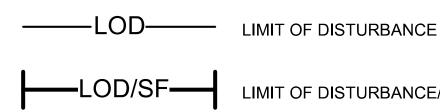

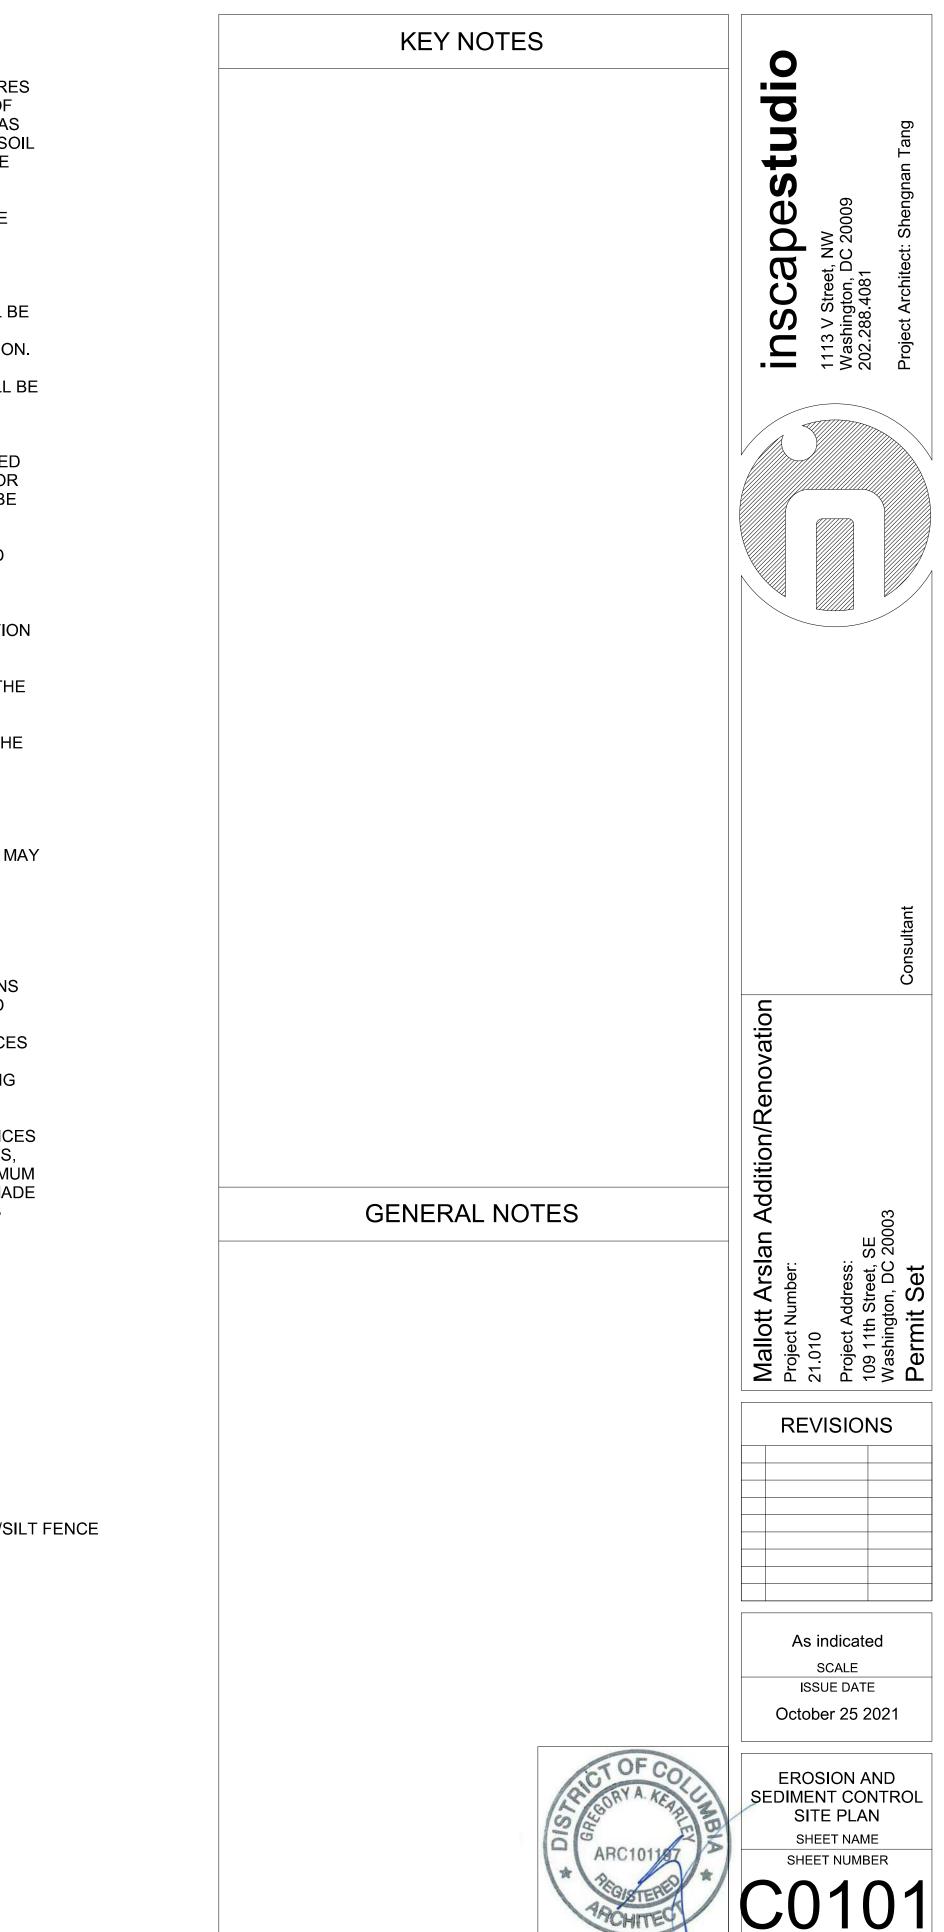

LIMIT OF DISTURBANCE/SILT FENCE

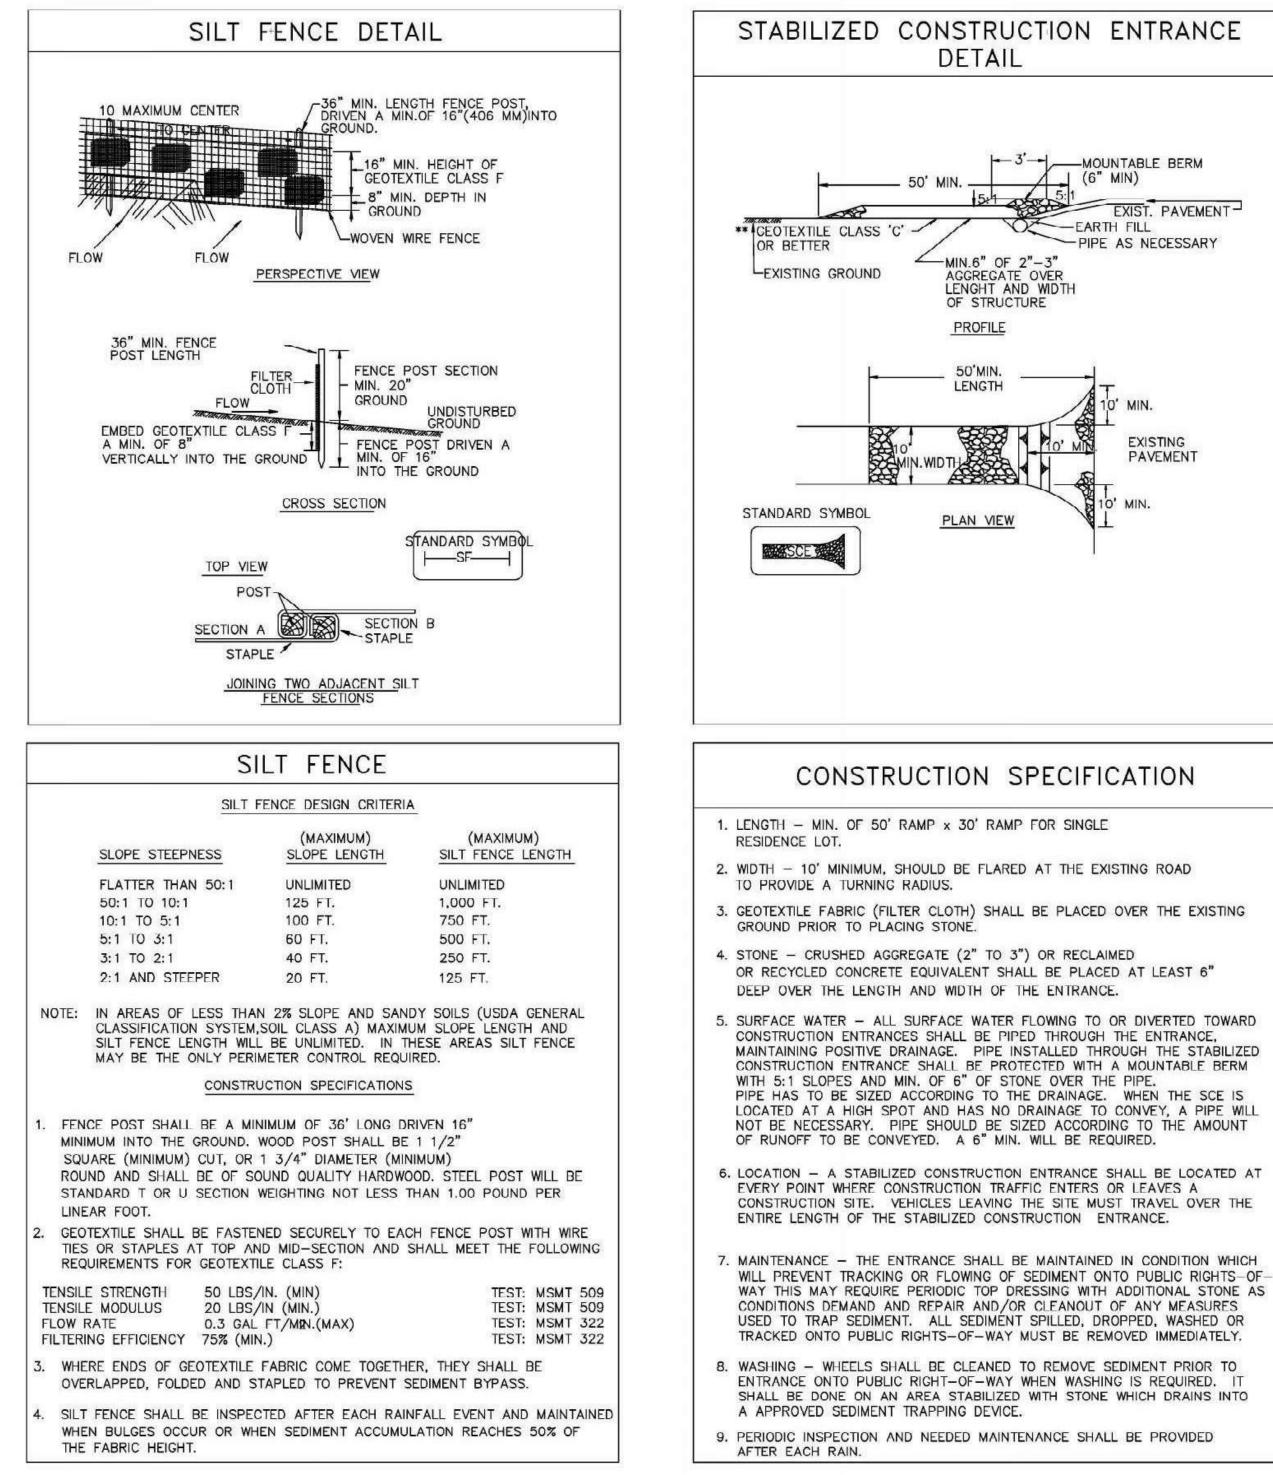

VEGETATIVE STABILIZATION

PERMANENT AND TEMPORARY SEEDING, SODDING AND MULCHING I. SITE PREPARATION

PERMANENT OR TEMPORARY STABILIZATION SHALL BE COMPLETED WITHIN (A) SEVEN AREAS ON THE PROJECT SITE.

CALENDAR DAYS AS TO THE SURFACE OF ALL SEDIMENT CONTROL PRACTICES SUCH AS DIVERSIONS, GRADE STABILIZATION STRUCTURES, BERMS, DIKES, GRASSED WATERWAYS, SEDIMENT BASINS, PERIMETER SLOPES, AND ALL SLOPES GREATER THAN 3 HORIZONTAL TO 1 VERTICAL (3:1) AND (B) FOURTEEN DAYS AS TO ALL OTHER DISTURBED OR GRADED II. SEEDBED PREPARATION AND SEEDING APPLICATION THE TOP LAYER OF SOIL SHALL BE LOOSENED, LIMED AND FERTILIZED BY RAKING, DISCING OR HARROWING OR OTHER ACCEPTABLE MEANS BEFORE SEEDING. FLAT AREAS AND SLOPES UP TO 3 TO 1 GRADE SHALL BE LOOSE AND FRIABLE TO A DEPTH OF AT LEAST 3 INCHES SLOPES STEEPER THAN 3 TO 1 SHALL HAVE THE TOP 1-3 INCHES OF SOIL LOOSE AND FRIABLE BEFORE SEEDING. FLAT AREAS AND SLOPES UP TO 3 TO 1 GRADE SHALL BE LOOSE AND FRIABLE TO A DEPTH OF AT LEAST 3 INCHES SLOPES STEEPER THAN 3 TO 1 SHALL HAVE THE TOP 1-3 INCHES OF SOIL LOOSE AND FRIABLE BEFORE SEEDING.

APPLY SEED UNIFORMLY WITH A CYCLONE SEEDER, DRILL CULTIPACKER, SEEDER OR HYDROSEEDER ON A FIRM MOIST SEEDBED.

III. SOIL AMENDMENTS

LIME AND FERTILIZE ACCORDING TO SOIL TESTS. IN LIEU OF SOIL TEST APPLY THE FOLLOWING:

DOLOMITIC 2 TONS PER ACRE OR 92 LBS/1,000 (PERMANENT AND SODDING SQ.FT.) LIMESTONE

FERTILIZER 1 TON PER ACRE OR 46 LB/1,000 (TEMPORARY) 10-10-10 OR EQUIVALENT AT 1,000 LBS PER ACRE OR 23 LBS PER 1,000 SQ. FT. (PERMANENT AND SODDING)

IV. SEDIMENT CONTROL PRACTICES, SEEDING

"KENTUCKY 31" TALL FESCUE 60 LBS/ACRE OR 1.38 LBS/1,000 SQ. FT AND SEED: ITALIAN (ANNUAL) RYEGRASS 40 LBS/ACRE OR .91 LBS/1,000 SQ. FT.

DATES: 1/2 - 10/31 5/1 - 8/14 WITH IRRIGATION

TEMPORARY SEEDING: PER GROWING SEASON

SEED: ITALIAN OR PERENNIAL RYEGRASS 40 LBS/ACRE LBS/1,000 SQ. FT. DATES: 2/1 - 4/30 AND 8/15 - 11/30 SEED: MILLET 40 LBS/ACRE OR 0.92 LBS/1,000 SQ. FT.

DATES: 5/1 - 8/14

VI. PERMANENT SEEDING

A. RESIDENTIAL AND HIGH MAINTENANCE AREAS

1. KENTUCKY BLUEGRASS, "PLUSH", "BIRKA", "PARADE", "VANTAGE", "COLUMBIA", "MERION", "ADELPHI", "SOUTH DAKOTA", "KENBLUE". ANY THREE VARIETIES AT 30 LBS. TO MAKE 90 LBS/ACRE OR 2 LBS/1,000 SQ.FT. AND RED FESCUE - "PENNLAWN" OR JAMESTOWN 10 LBS/1000 SQ.FT.

DATES: 2/1 - 4/30 AND 8/15 - 10/31.

2. "KENTUCKY 31" TALL FESCUE 220-260 LBS/ACRE OR 5-6 LBS/1,000 SQ. FT. 2/1 - 10/31 5/1 - 8/14 IRRIGATION REQUIRED. B. LOW DATES: MAINTENANCE AND MINING AREAS "KENTUCKY 31" TALL FESCUE 40 LBS/ACRE OR 0.92 LBS/1,000 SQ. FT. AND "INTERSTATE" SERICEA LESPEDEZA (INOCULATED)20 LBS/ACRE OR 0.46 LBS/1.000 SQ. FT.

DATES: 2/1 - 4/30 AND 8/15 - 10/31

C. GENERAL AND LARGE ACREAGE "KENTUCKY 31" TALL FESCUE 60 LBS./ACRE OR 1.38 LBS/1,000 SQ.FT.(0.5 kg/100 sq.m)

VII. MULCHING

ALL SEEDINGS REQUIRE MULCHING. USE MULCH ONLY DURING NON-SEEDING DATES UNTIL SEEDING CAN BE DONE. MULCH SHALL BE UNROTTED, UNCHOPPED SMALL GRAIN STRAW APPLIED AT A RATE OF 1 TO 2 TONS/ACRE OR 70-90 LBS/1,000 SQ.FT. (2 BALES) MULCH MATERIALS SHALL BE RELATIVELY FREE OF ALL KINDS OF WEED BEDS AND SHALL BE FREE OF PROHIBITED NOXIOUS WEEDS. SPREAD MULCH UNIFORMLY MECHANICALLY OR BY HAND. MULCH ANCHORING SHALL BE ACCOMPLISHED IMMEDIATELY AFTER MULCH PLACEMENT TO MINIMIZE LOSS BY WIND OR WATER. THIS MAY BE DONE BY MULCH NETTINGS, MULCH ANCHORING TOOL, PEG AND TWIN OR LIQUID MULCH BINDERS. LIQUID MULCH BINDER SHALL BE RAPID CURING CUTBACK ASPHALT APPLIED AT A RATE OF 200 GAL/ACRE OR 5 GAL. PER 1,000 SQ. FT. SLOPES 8 FEET OR MORE HIGH USE 348 GAL./ACRE OR 8 GAL./1,000 SQ. FT.

VII. SODDING

CLASS OF TURFGRASS SOD SHALL BE MARYLAND OR VIRGINIA STATE CERTIFIED OR MARYLAND OR VIRGINIA STATE APPROVED SOD. SOD SHALL BE HARVESTED, DELIVERED AND INSTALLED WITHIN A PERIOD OF 36 HOURS. SOD IS TO BE LAID WITH THE LONG EDGES PARALLEL TO THE CONTOUR WITH STAGGERED JOINTS WITH ALL ENDS TIGHTLY ABUTTING AND NOT OVERLAPPING. SOD SHALL BE ROLLED AND THOROUGHLY WATERED WITHIN EIGHT HOURS OF INSTALLATION. DAILY WATERING TO MAINTAIN 4 INCH DEPTH OF MOISTURE FOR THE FIRST WEEK IS REQUIRED IN THE ABSENCE OF RAINFALL. SOD IS NOT TO BE APPLIED ON FROZEN GROUND.

IX. MAINTENANCE

A. IRRIGATION - WHEN SOIL MOISTURE BECOMES DEFICIENT, IRRIGATE TO PREVENT LOSS OF STAND OF PROTECTIVE VEGETATION. B. REPAIRS - IF STAND IS INADEQUATE FOR EROSION CONTROL. OVERSEED AND FERTILIZE USING HALF OF THE RATES ORIGINALLY APPLIED. IF STAND IS OVER 60% DAMAGED, REESTABLISH FOLLOWING ORIGINAL RATES AND PROCEDURES.

NOTE: USE OF THIS INFORMATION DOES NOT PRECLUDE MEETING ALL OF THE REQUIREMENTS OF THE 1987 DISTRICT OF COLUMBIA DEPARTMENT OF CONSUMER AND REGULATORY AFFAIRS STANDARDS AND SPECIFICATIONS FOR SOIL EROSION AND SEDIMENT CONTROL VEGETATIVE PRACTICES.

OR .92

ation dition/Renov. GENERAL NOTES SE 20 Arsla Street, ton, DC t Set Mallott , Project Nur 21.010 <u>:</u>: Proje 109 Was REVISIONS SCALE ISSUE DATE October 25 2021 EROSION AND SEDIMENT CONTROL DETAILS AND NOTES SHEET NAME SHEET NUMBER

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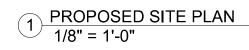
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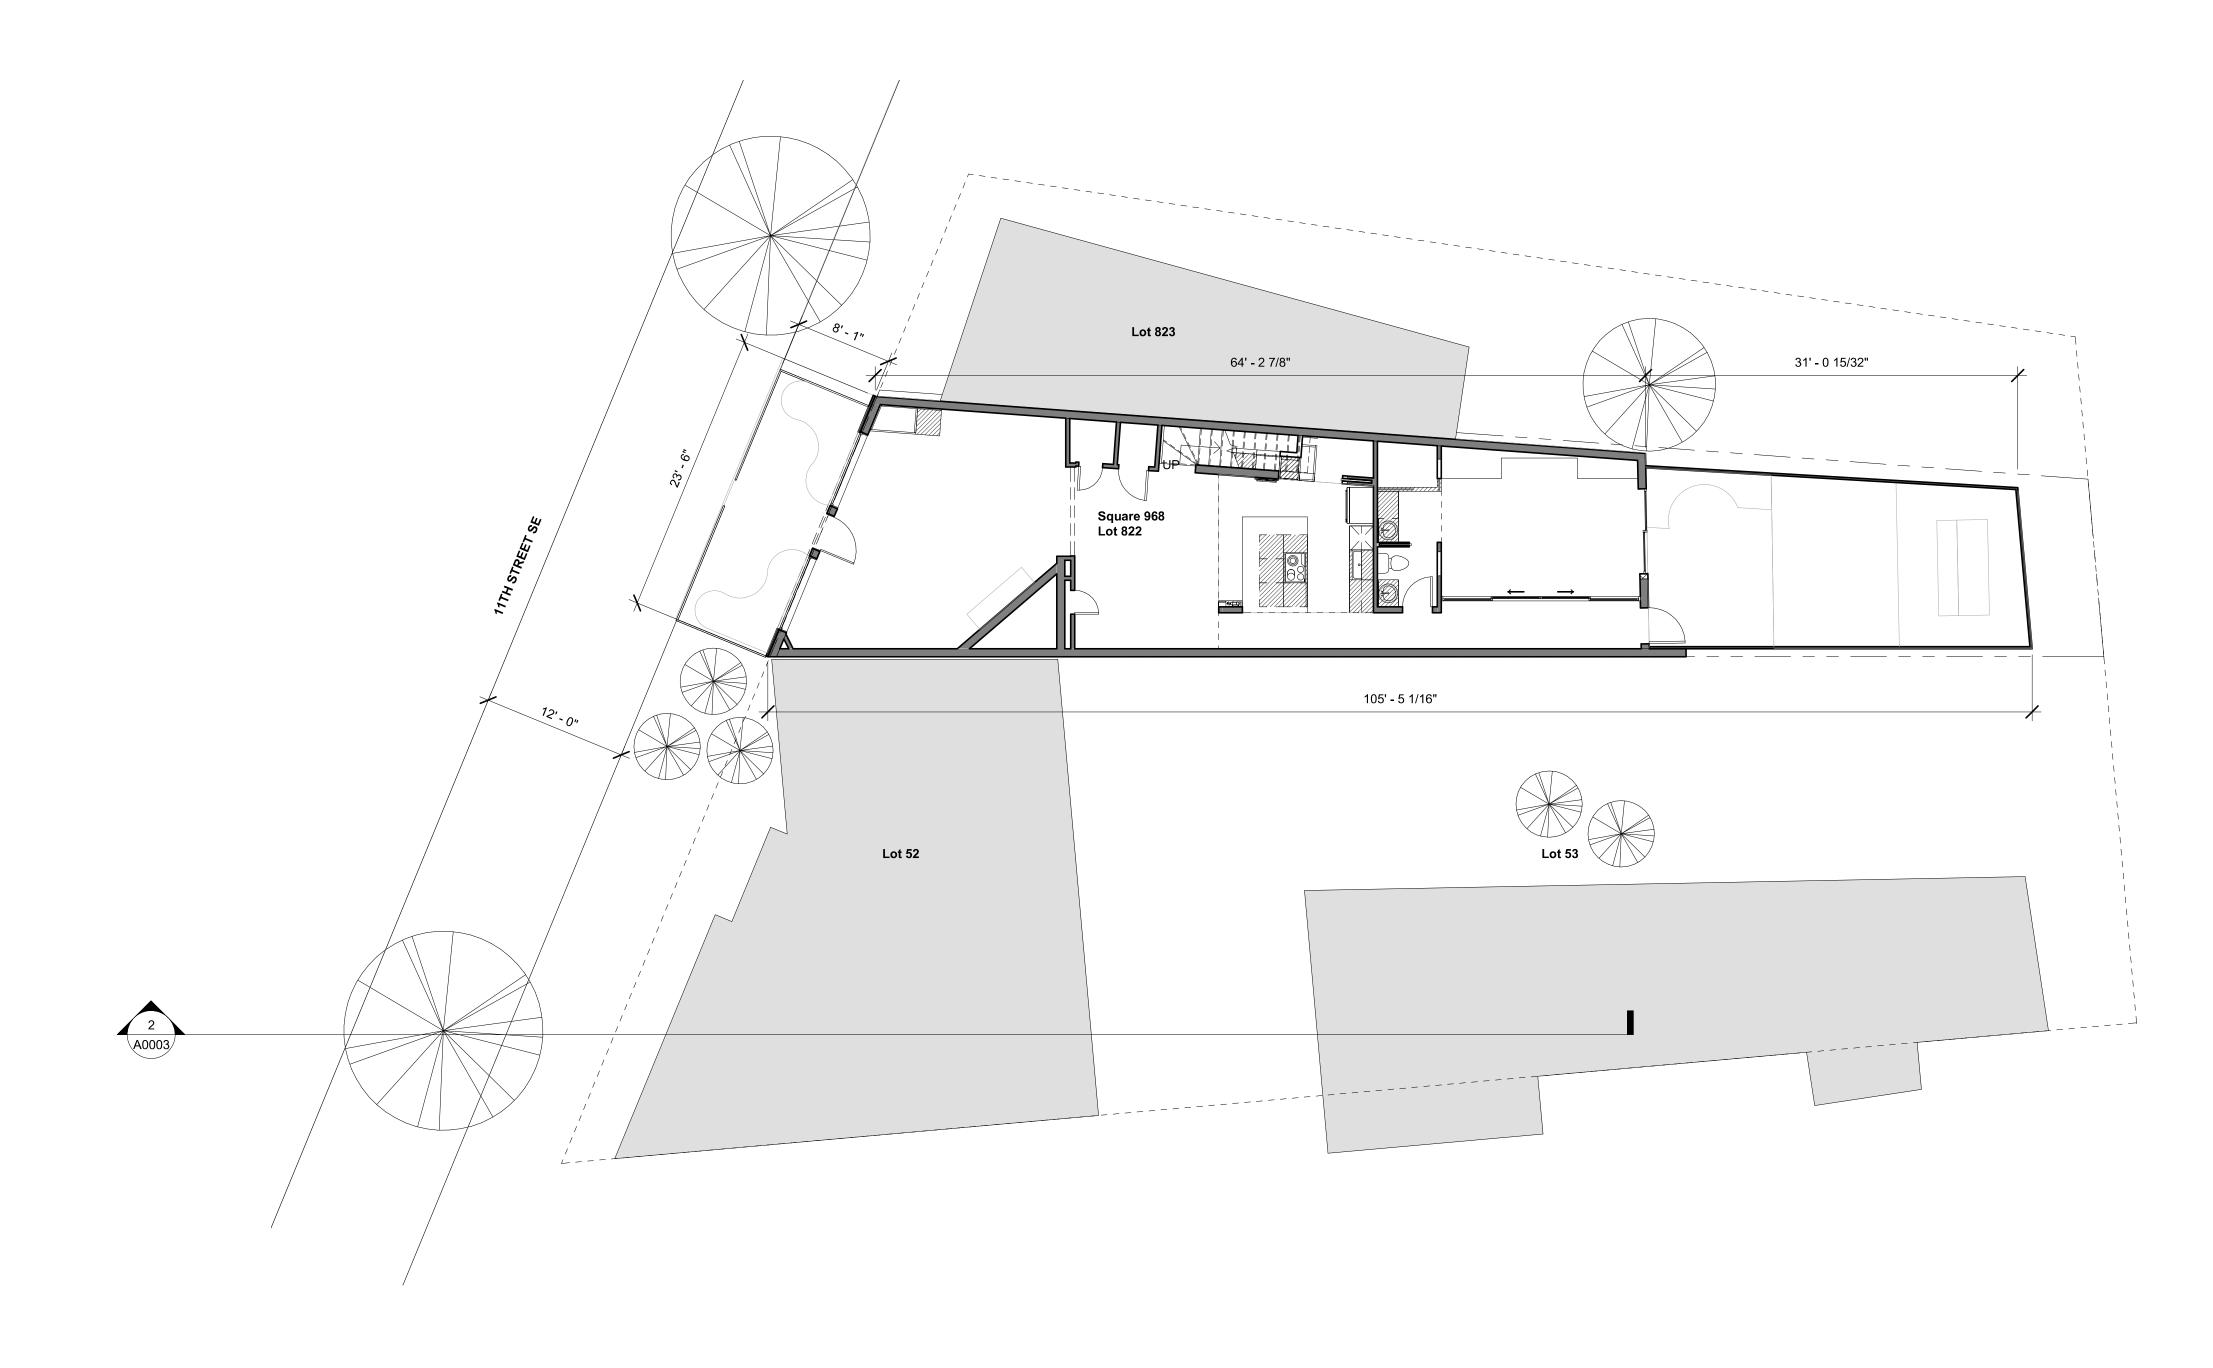
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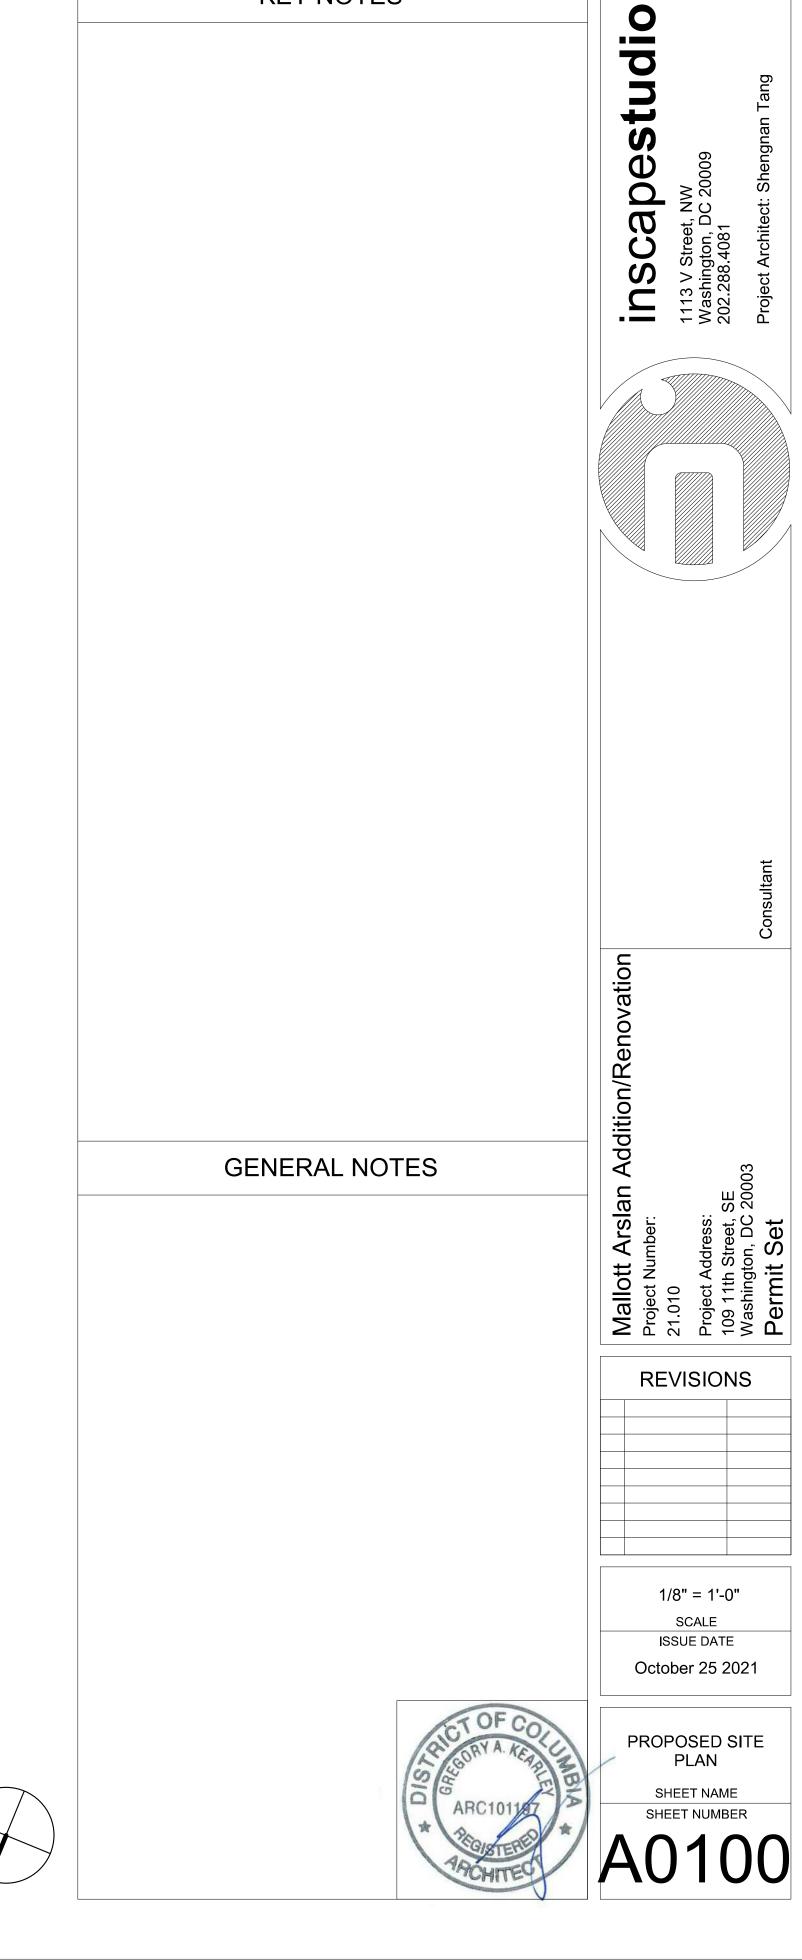
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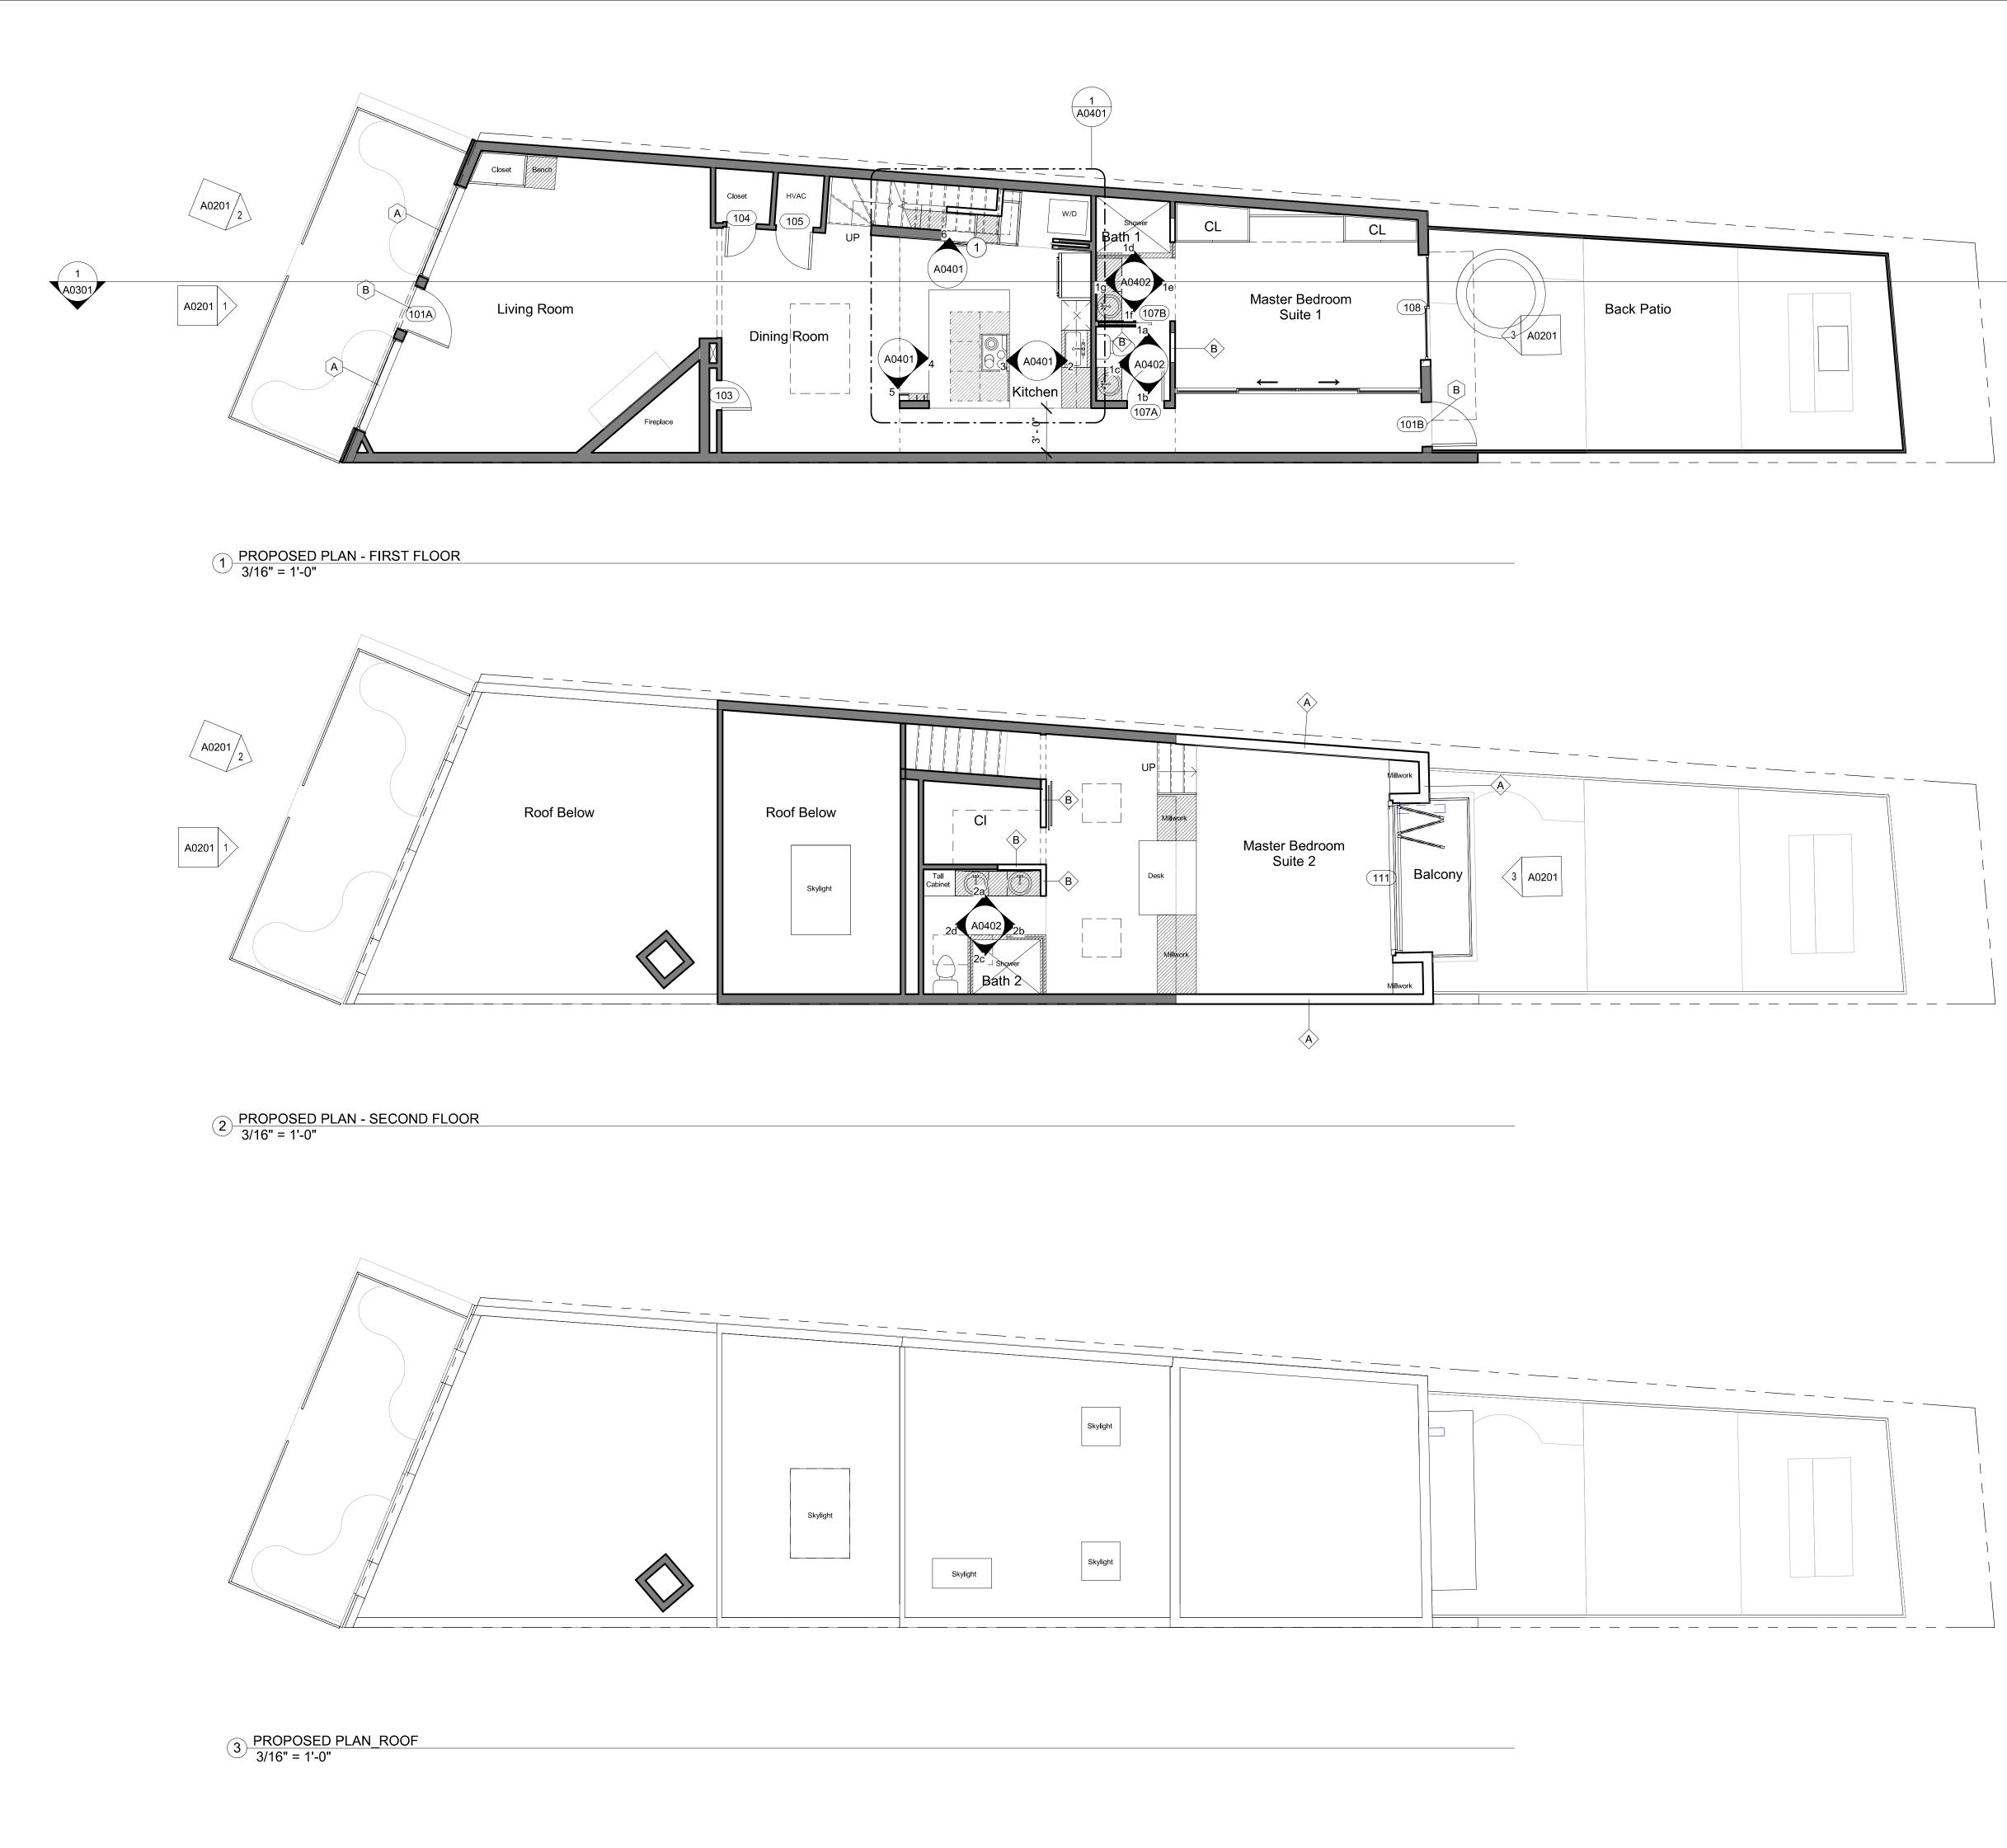
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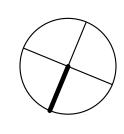







KEY NOTES






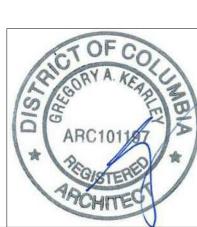





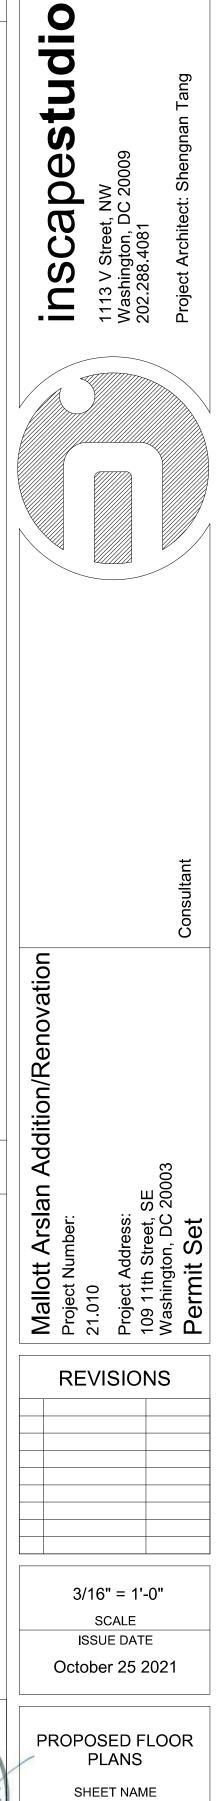


SHEET NUMBER

KEY NOTES

1 PROVIDE WATERLINE FOR COFFEE MACHINE.



2 FINISH PLAN - SECOND FLOOR 3/16" = 1'-0"

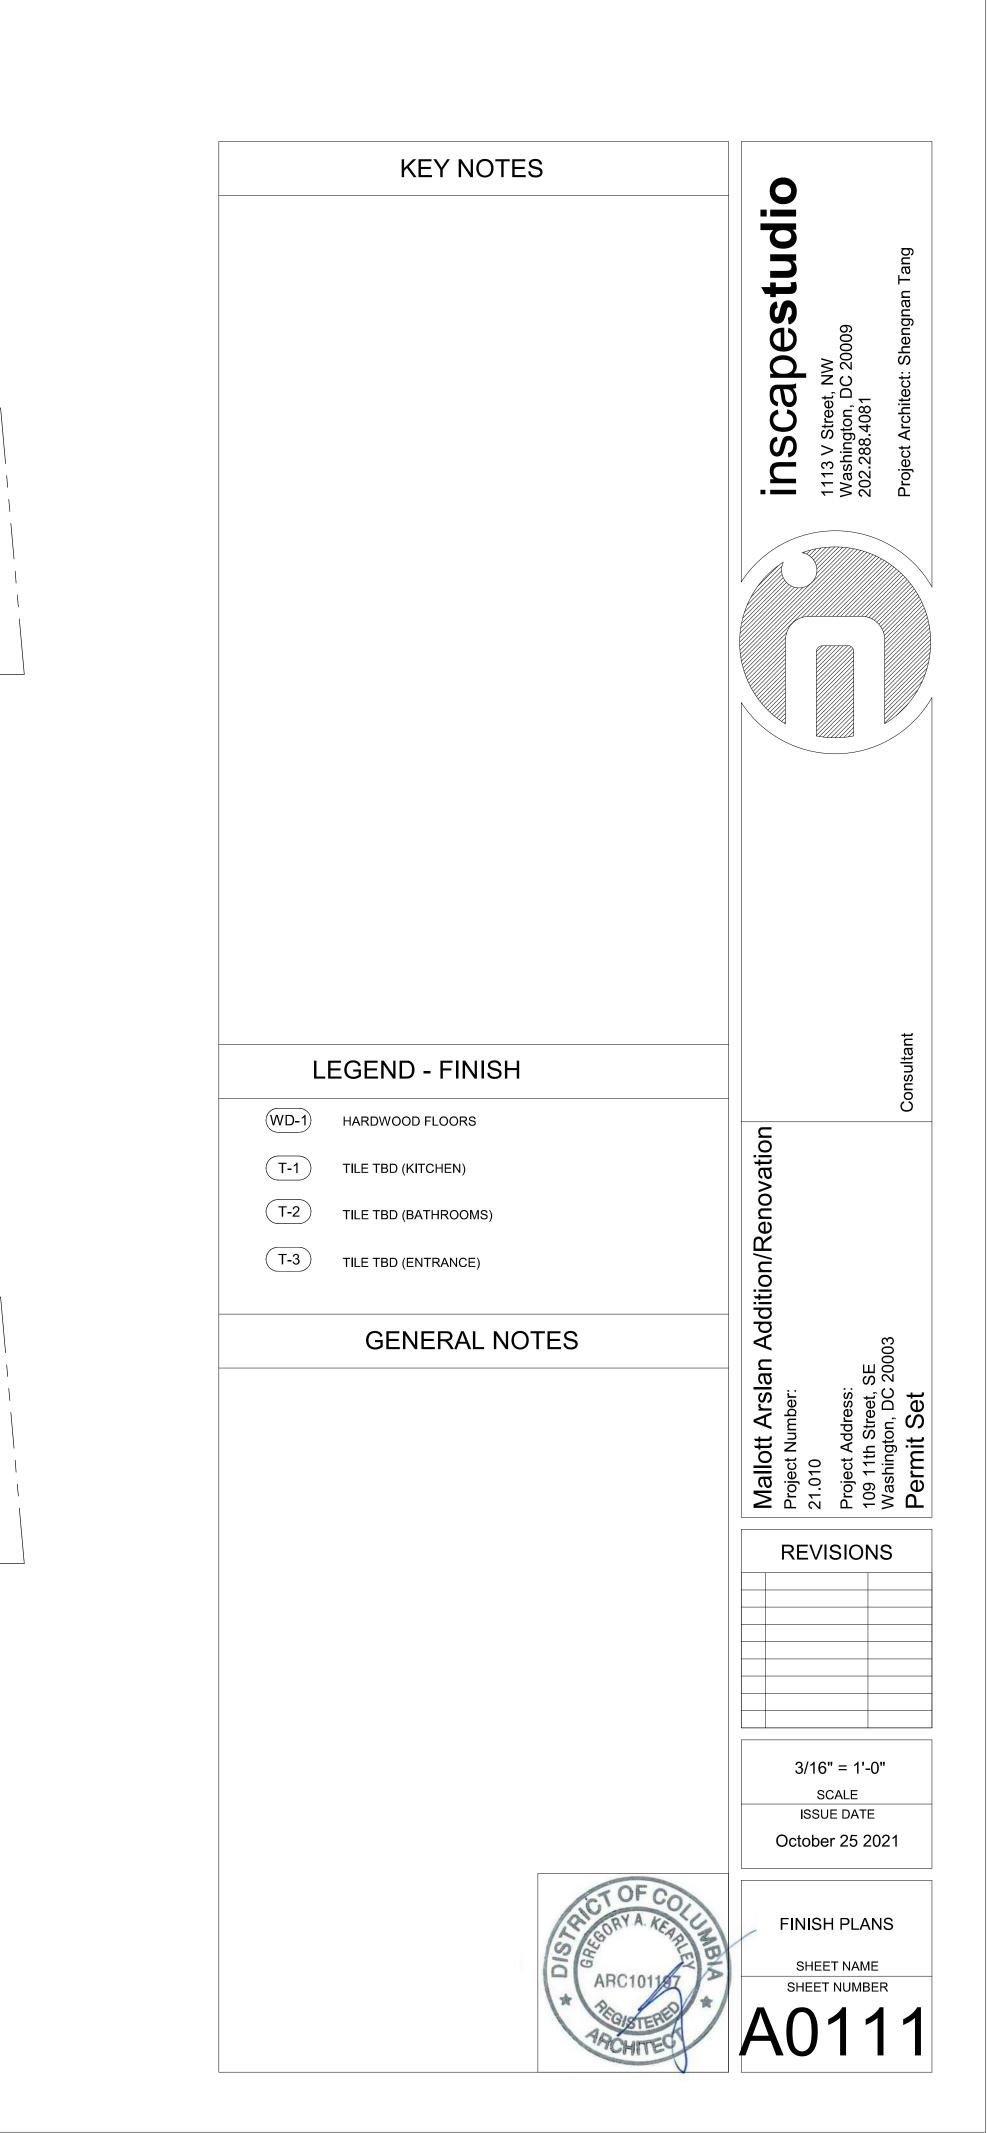





2 POWER PLAN - SECOND FLOOR 3/16" = 1'-0"

KEY NOTES

- 1 PROVIDE POWER (220 V) FOR JACUZZI. 2 PROVIDE POWER FOR ELECTRIC HEATED FLOOR IN BATHROOMS.
- 3 PROVIDE POWER FOR WASHER AND DRYER.
- 4 PROVIDE POWER FOR BACKYARD LIGHTING. 5 PROVIDE POWER FOR BUILT IN COFFEE MACHINE.
- 6 PROVIDE POWER FOR BUILT IN OVEN.

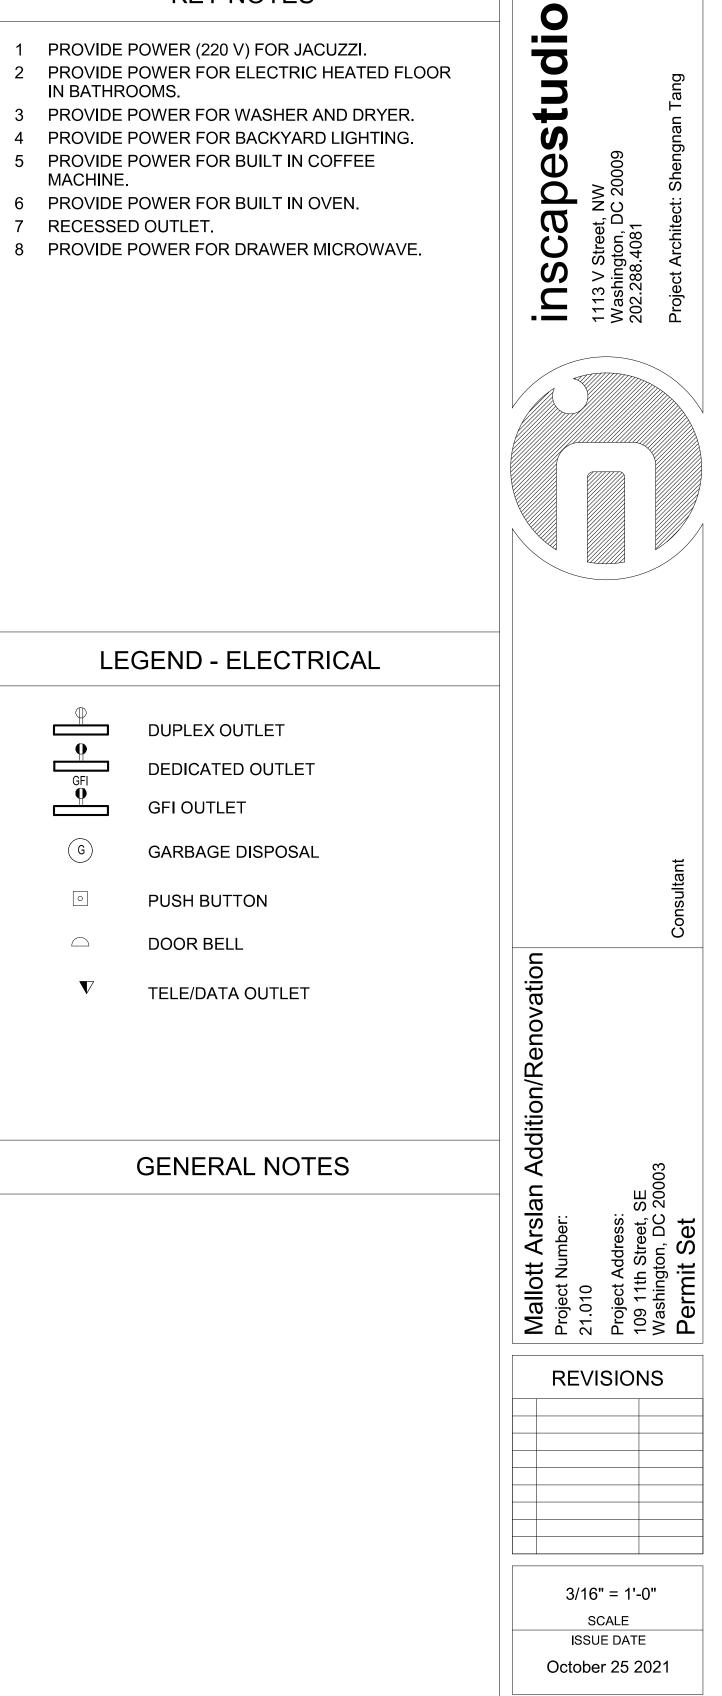


60

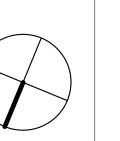





POWER PLANS


SHEET NAME SHEET NUMBER

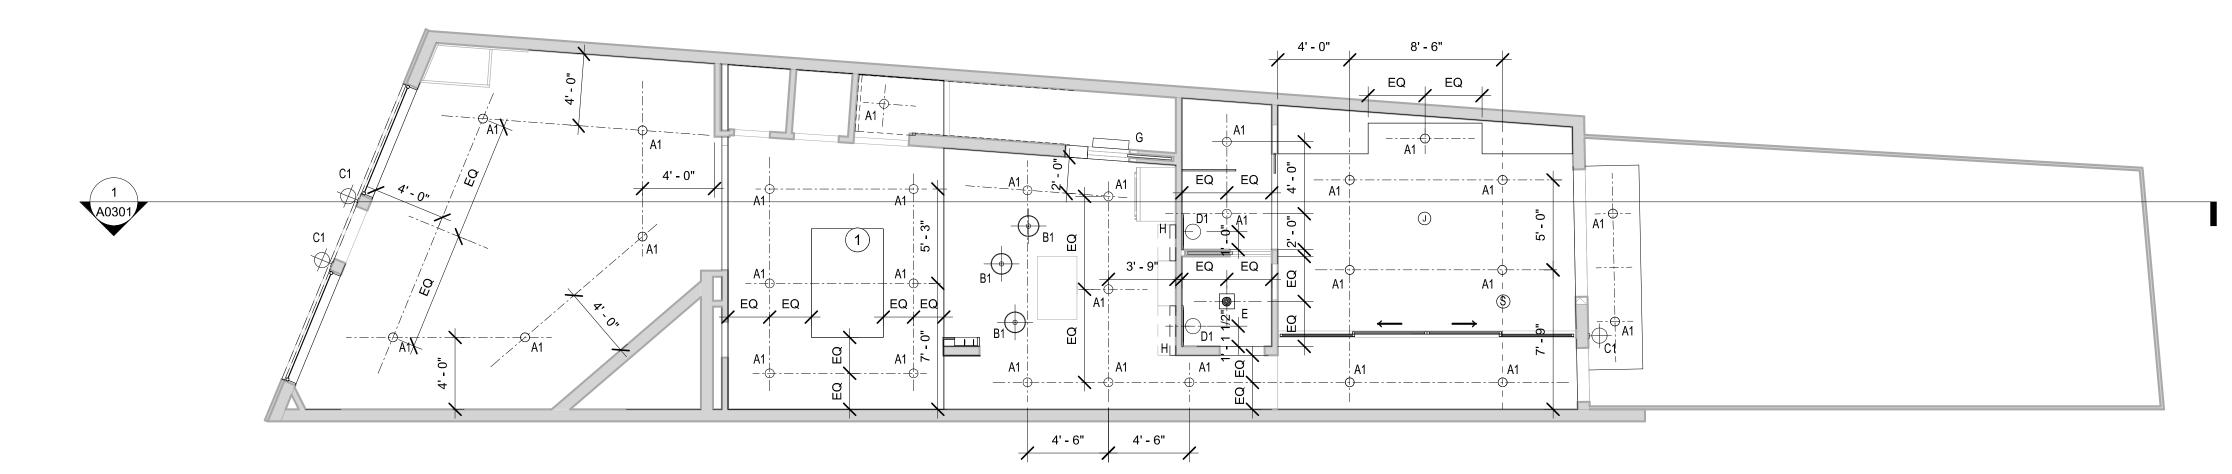


1 RCP - FIRST FLOOR 3/16" = 1'-0"

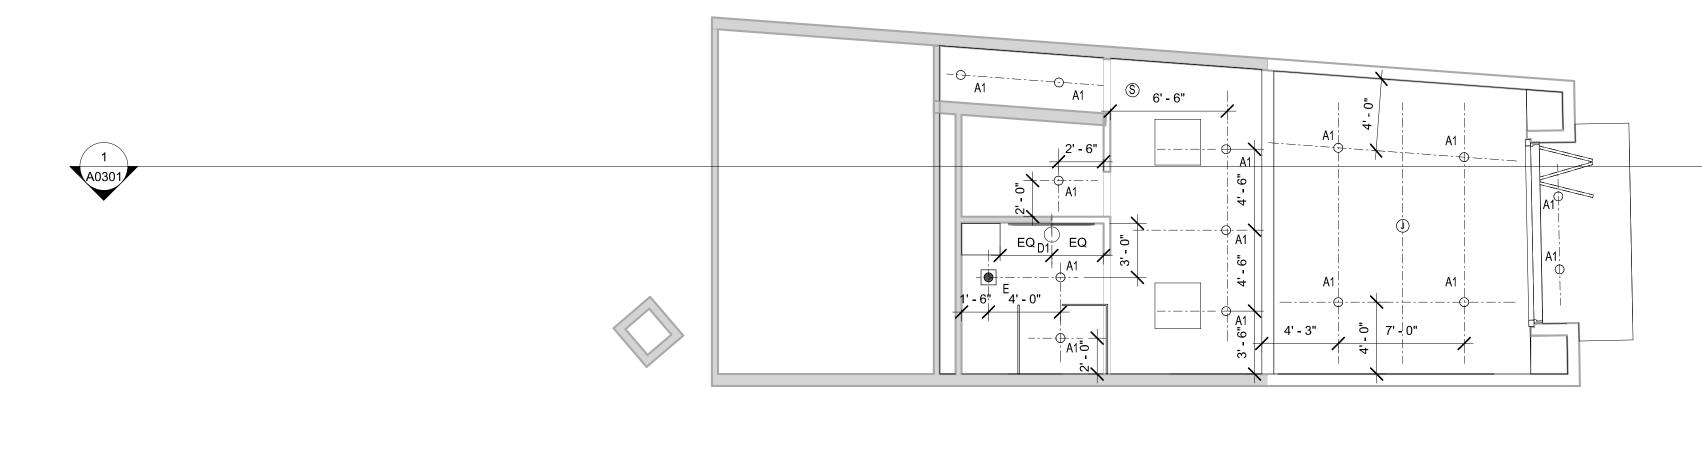

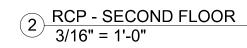


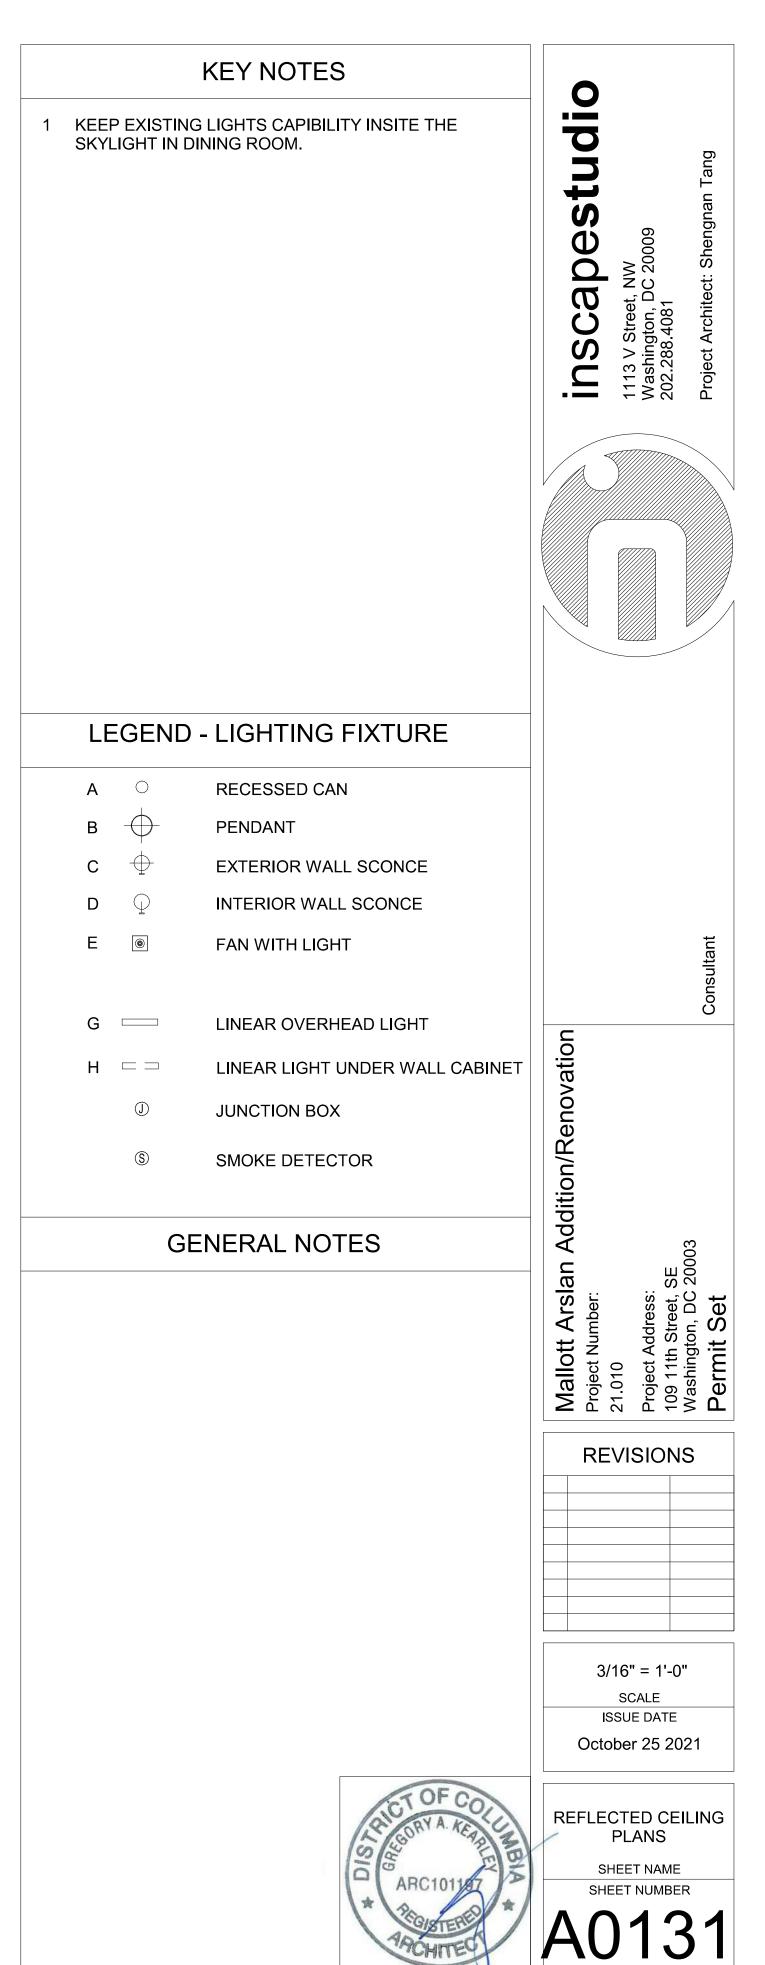



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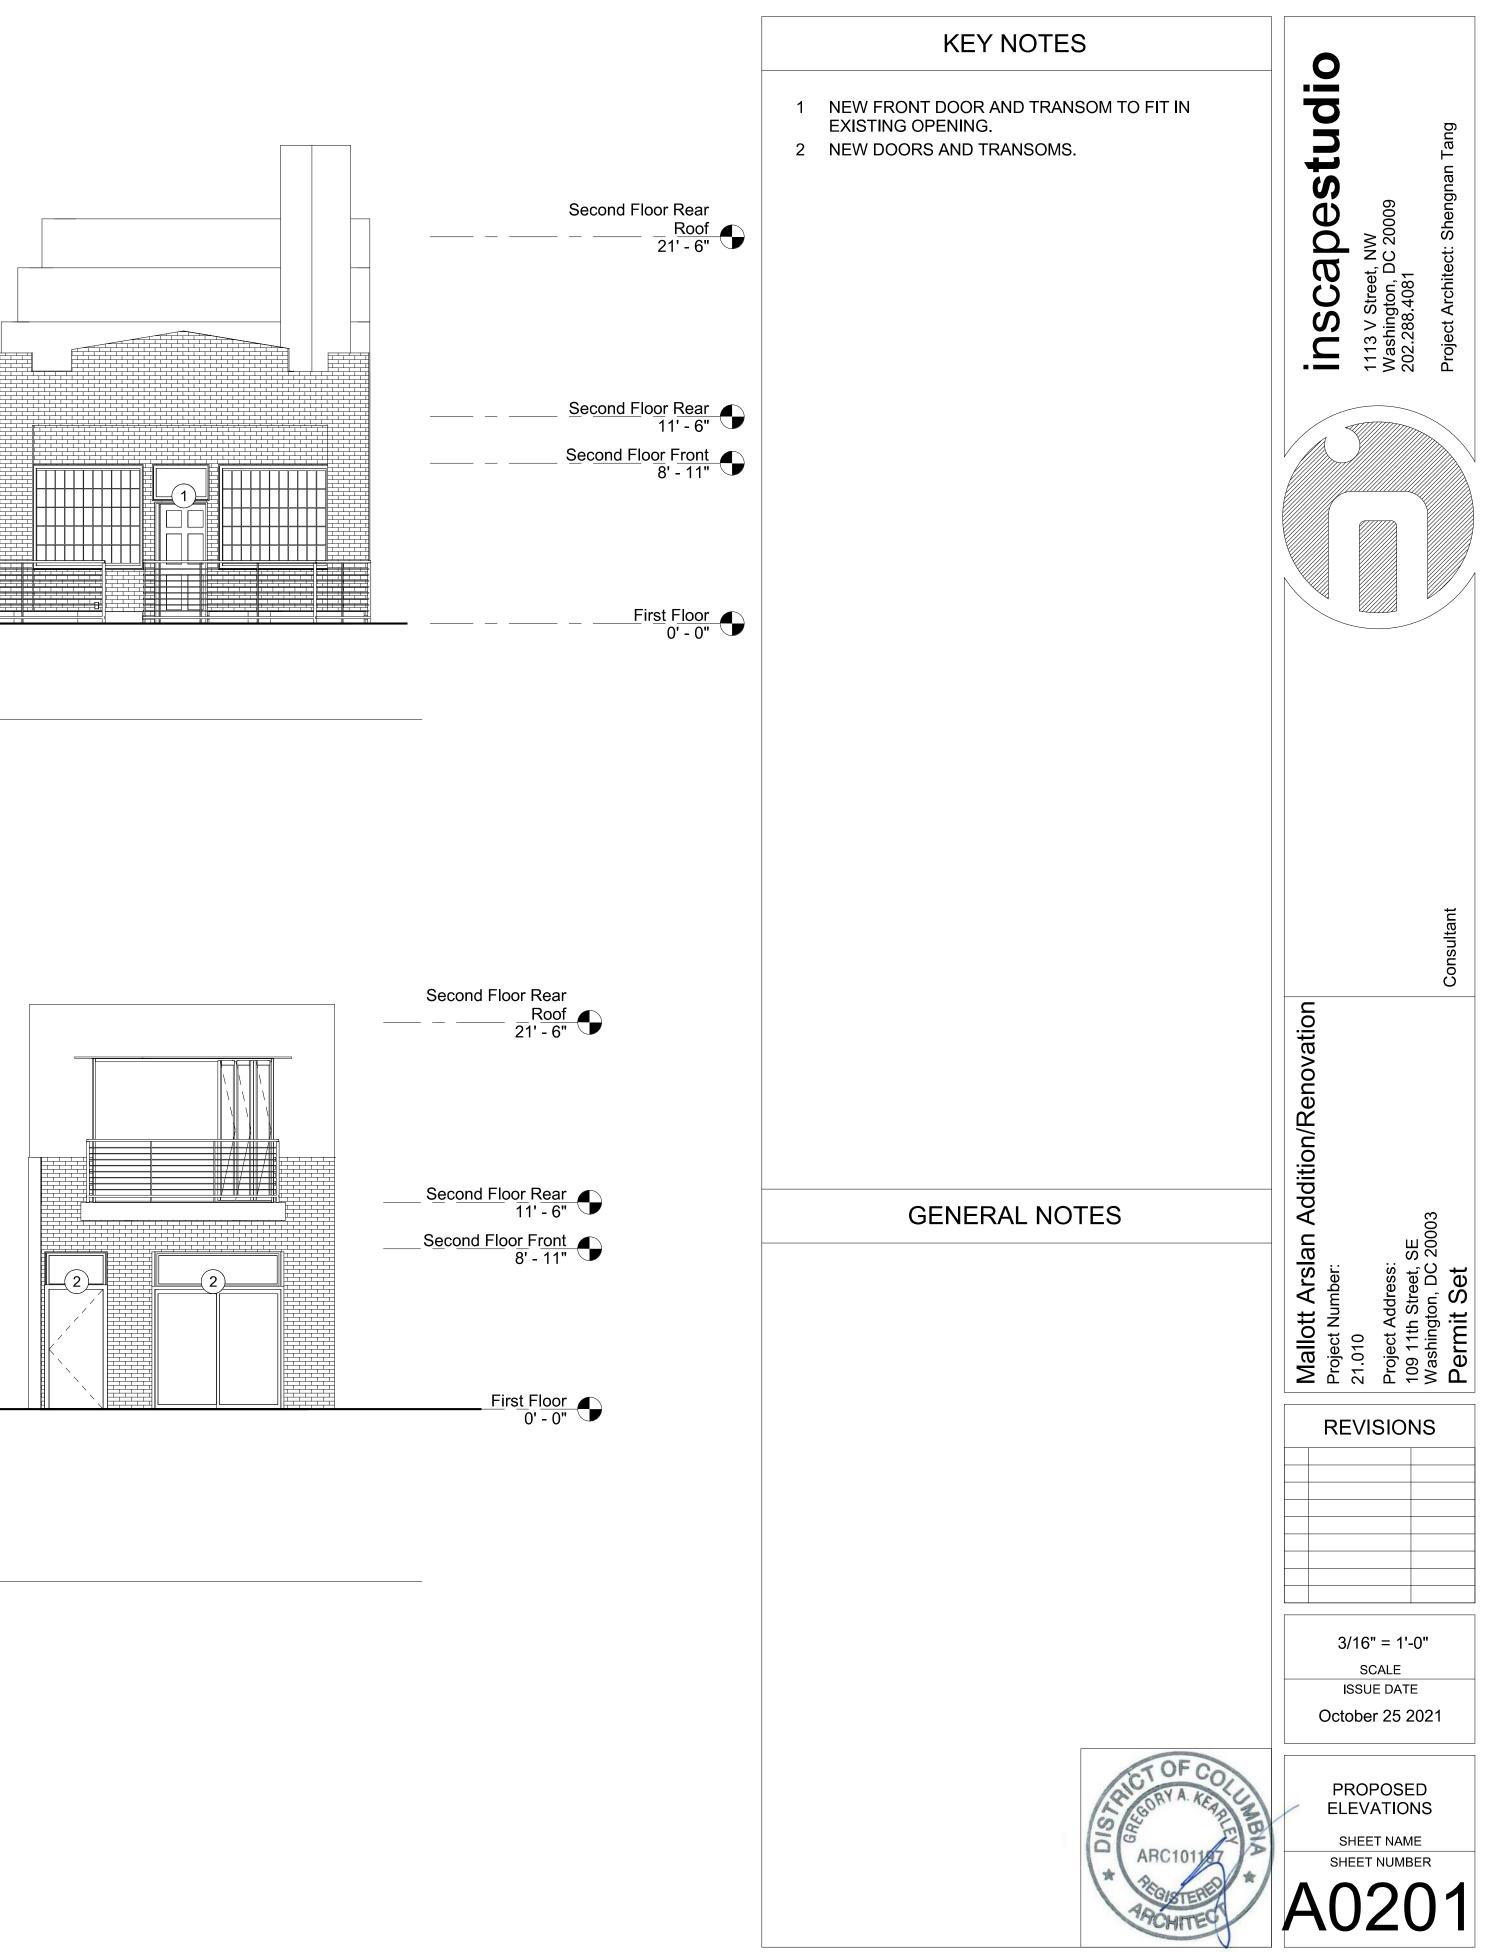


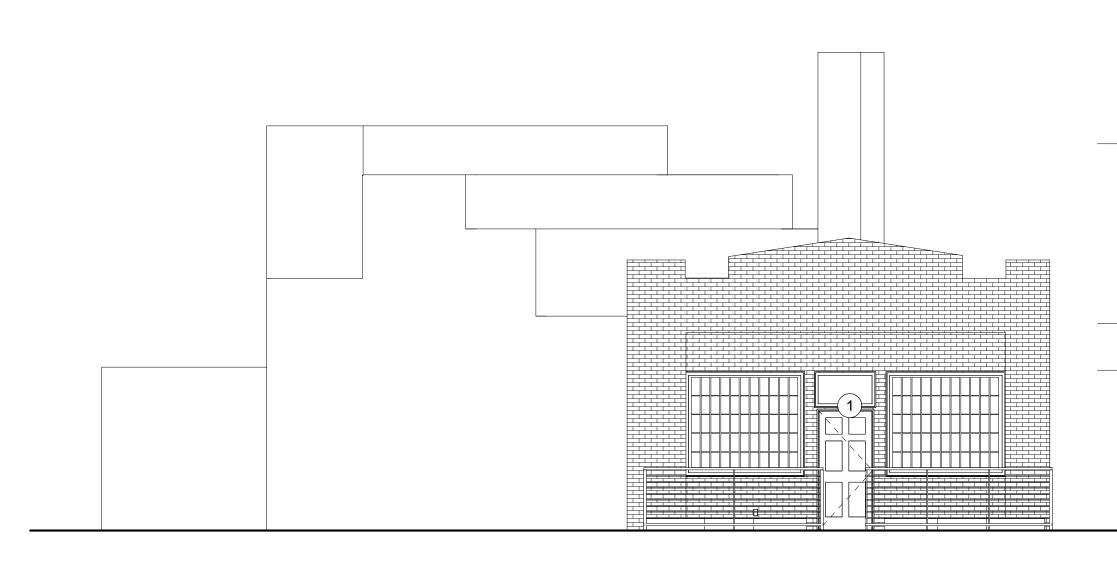2 ELEVATION - FRONT - 2 3/16" = 1'-0"



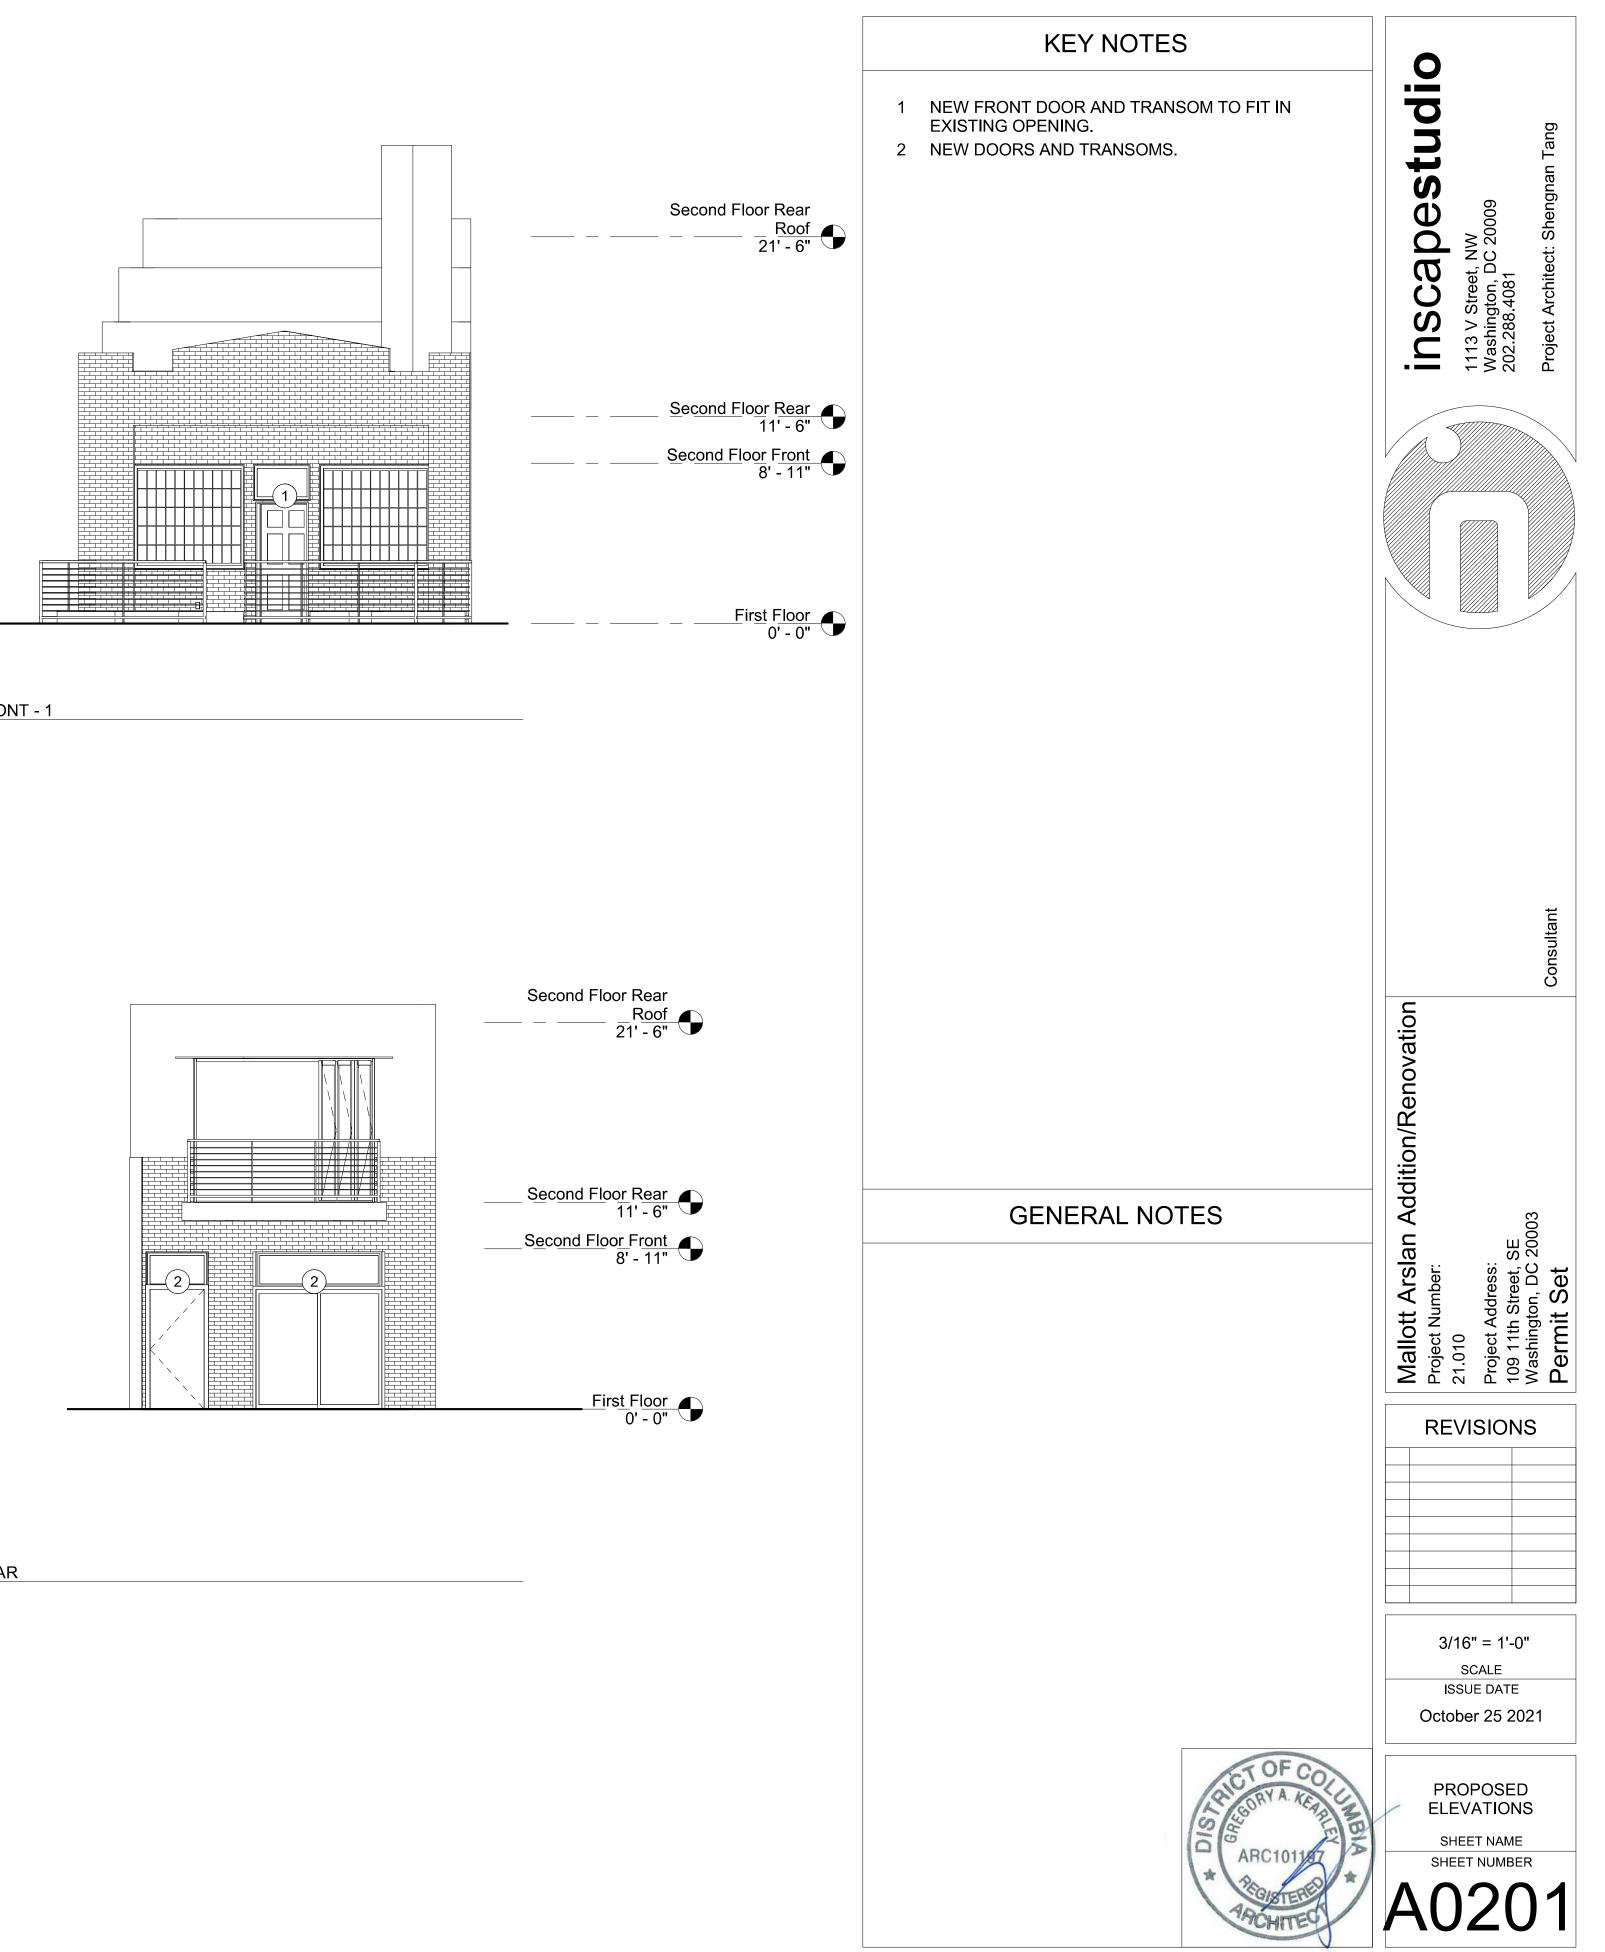

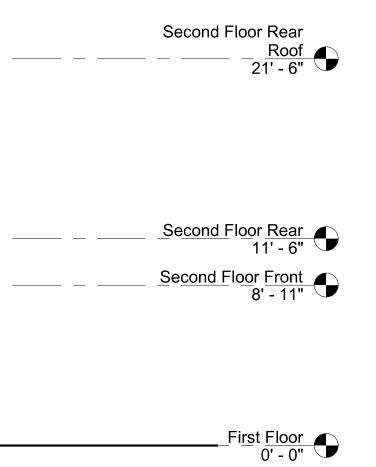

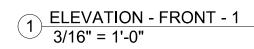

3 ELEVATION - REAR 3/16" = 1'-0"